



SEE SHEET #68 FOR CONTINUATION

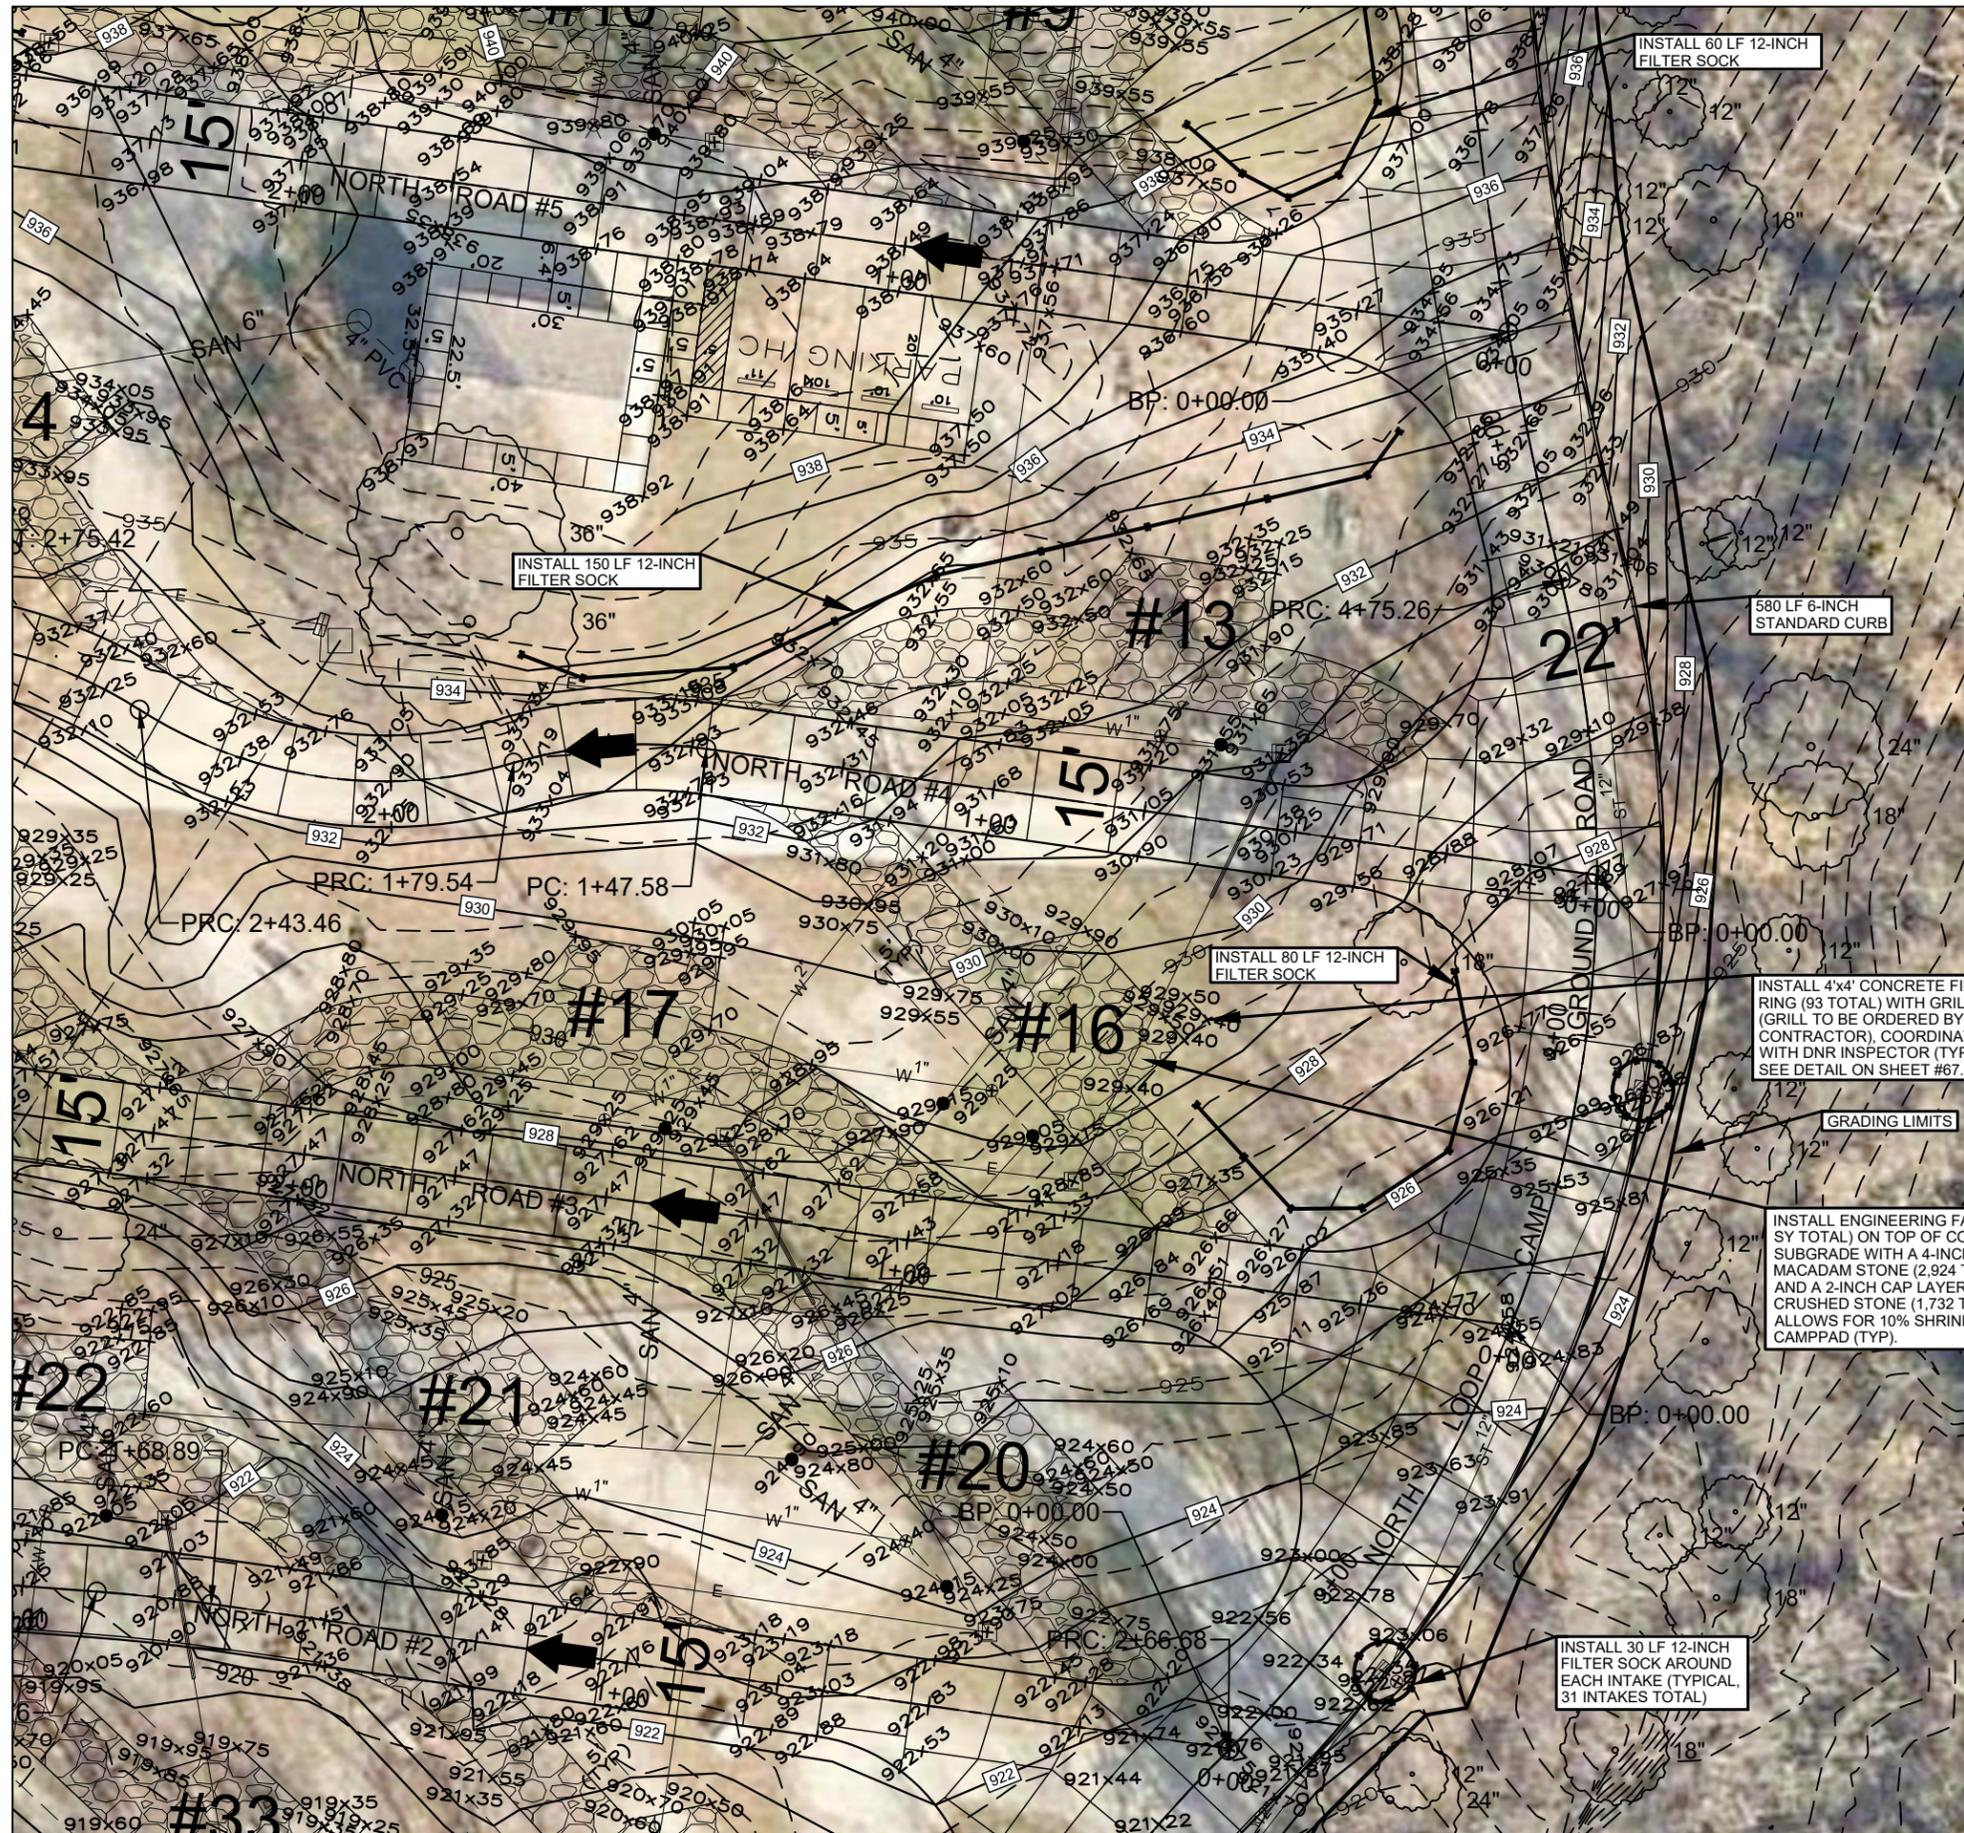

SEE SHEET #70 FOR CONTINUATION

SEE SHEET #71 FOR CONTINUATION

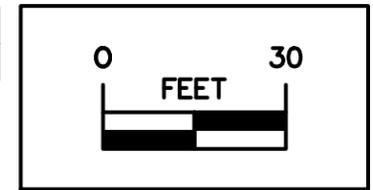


LEGEND

EXISTING/PROPOSED

- SAN 6" — SANITARY SEWER
- ST 12" — STORM SEWER
- E — ELECTRIC LINE
- W 2" — WATER MAIN
- ● MANHOLE/CLEANOUT
- ♀ ♀ HYDRANT
- ⊗ ⊗ VALVE
- 990 — ELEVATION
- 1144x50 — SPOT ELEVATION
- x x x — FILTER SOCK
- z z z — DRAINAGE SWALE

CONSULTANT:

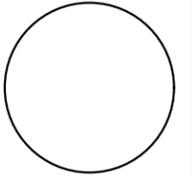

IOWA DEPARTMENT OF
NATURAL RESOURCES

ENGINEERING SERVICES - WALLACE BUILDING
502 E. 9TH ST., DES MOINES, IA 50319-0034



GRADING PLAN

CONSTRUCTION PROJECT FOR:

LAKE AHQUABI CAMPGROUND
UPGRADE PROJECT

WARREN COUNTY, IOWA

NO.	DATE	REVISION


DRAWN BY: PROJECT NUMBER:
22-05-91-01

CHKD BY: DATE:
12/29/2021

SHEET No:

SEE SHEET #75 FOR CONTINUATION


SEE SHEET #74 FOR CONTINUATION

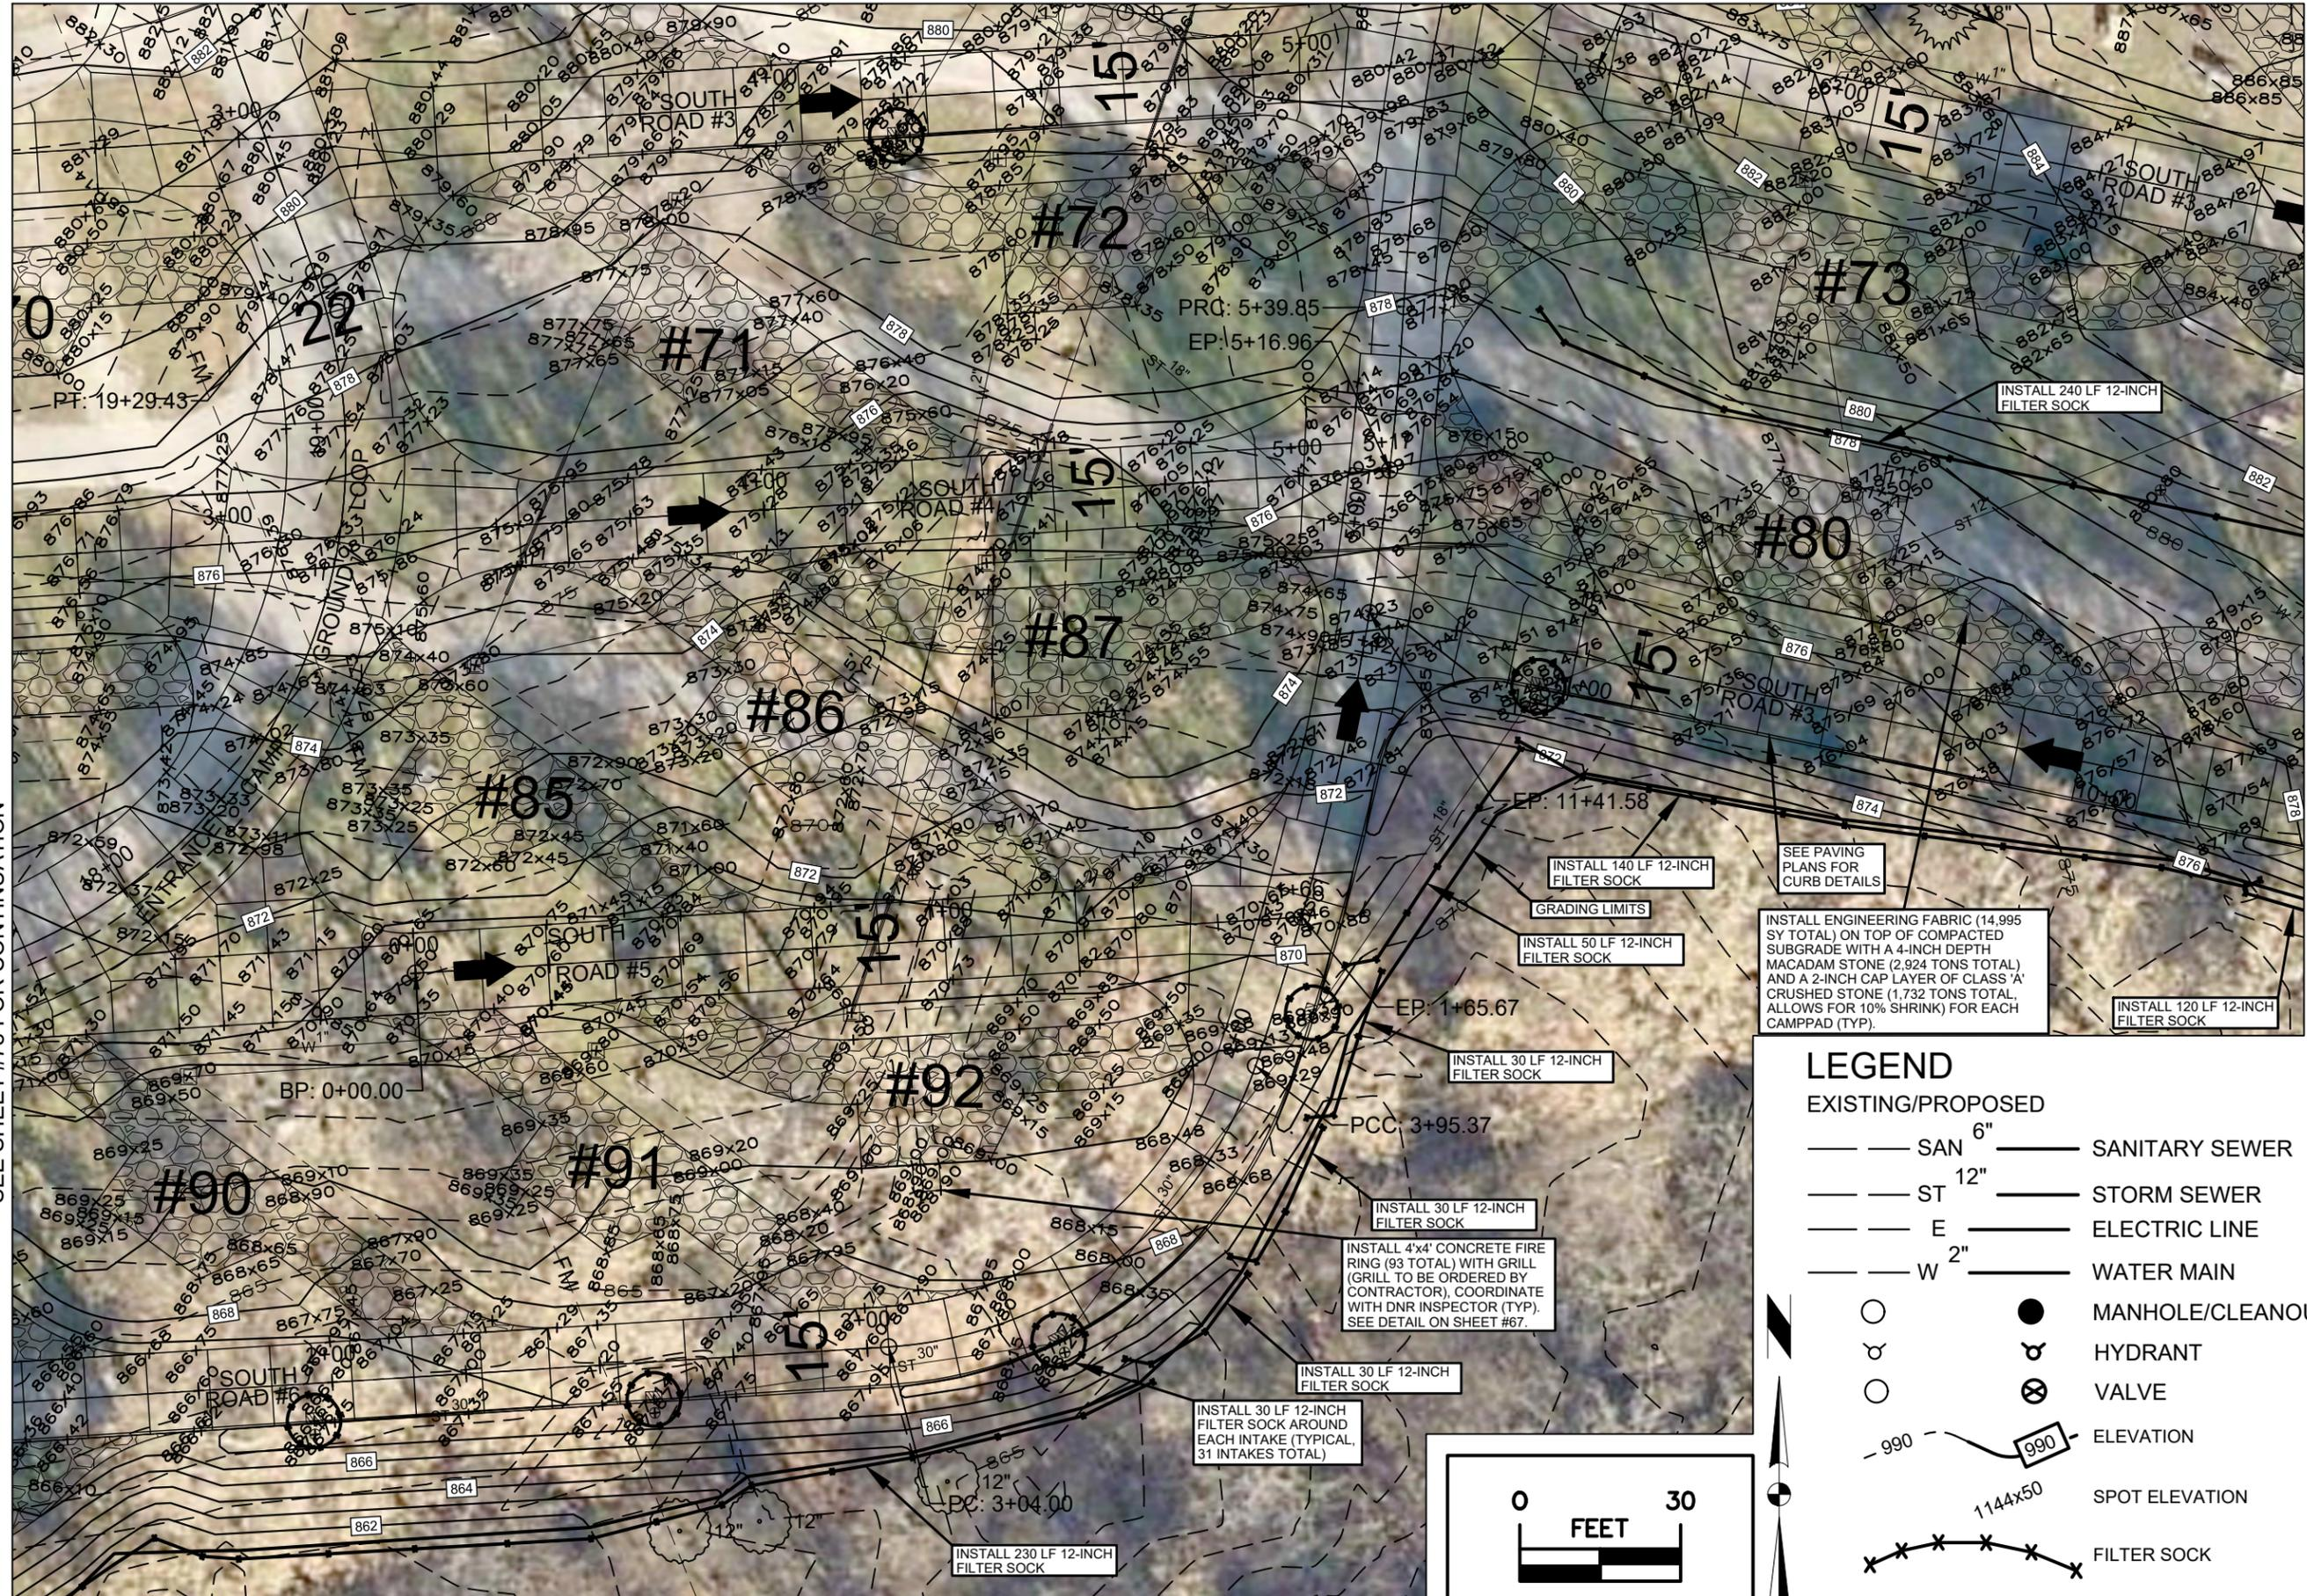

SEE SHEET #78 FOR CONTINUATION

SEE SHEET #76 FOR CONTINUATION

CONSULTANT:

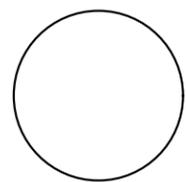

**IOWA DEPARTMENT OF
NATURAL RESOURCES**

ENGINEERING SERVICES - WALLACE BUILDING
502 E. 9TH ST., DES MOINES, IA 50319-0034



GRADING PLAN


CONSTRUCTION PROJECT FOR:

**LAKE AHQUABI CAMPGROUND
UPGRADE PROJECT**

WARREN COUNTY, IOWA

LEGEND

- EXISTING/PROPOSED
- SAN 6" — SANITARY SEWER
 - ST 12" — STORM SEWER
 - E — ELECTRIC LINE
 - W 2" — WATER MAIN
 - — MANHOLE/CLEANOUT
 - — HYDRANT
 - ⊗ — VALVE
 - — ELEVATION
 - — SPOT ELEVATION
 - x — FILTER SOCK
 - z — DRAINAGE SWALE

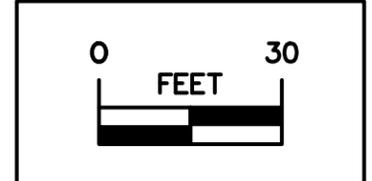

NO.	BY	REVISION

DRAWN BY:	PROJECT NUMBER:
CHKD BY:	DATE:
SHEET NO.:	

SEE SHEET #93 FOR SOUTH ROAD #2 INFO

SEE SHEETS #94-95 FOR SOUTH ROAD #3 INFO




SEE SHEET #96 FOR SOUTH ROAD #4 INFO

SEE SHEET #85 FOR CONTINUATION

LEGEND

EXISTING/PROPOSED

		MANHOLE
		INTAKE
		HYDRANT
		VALVE
		OUTLET POST
		POWER POLE/ LIGHT POLE

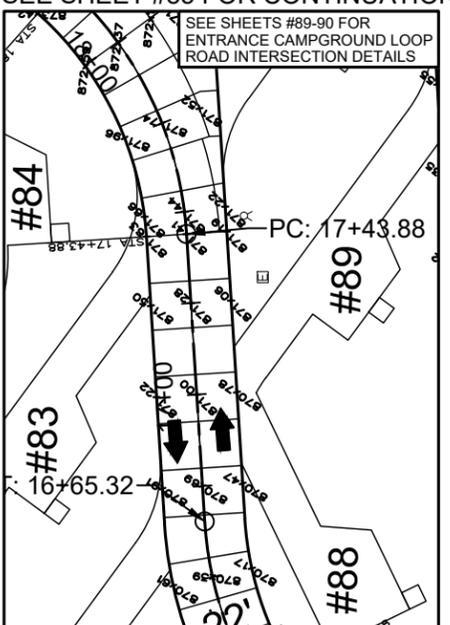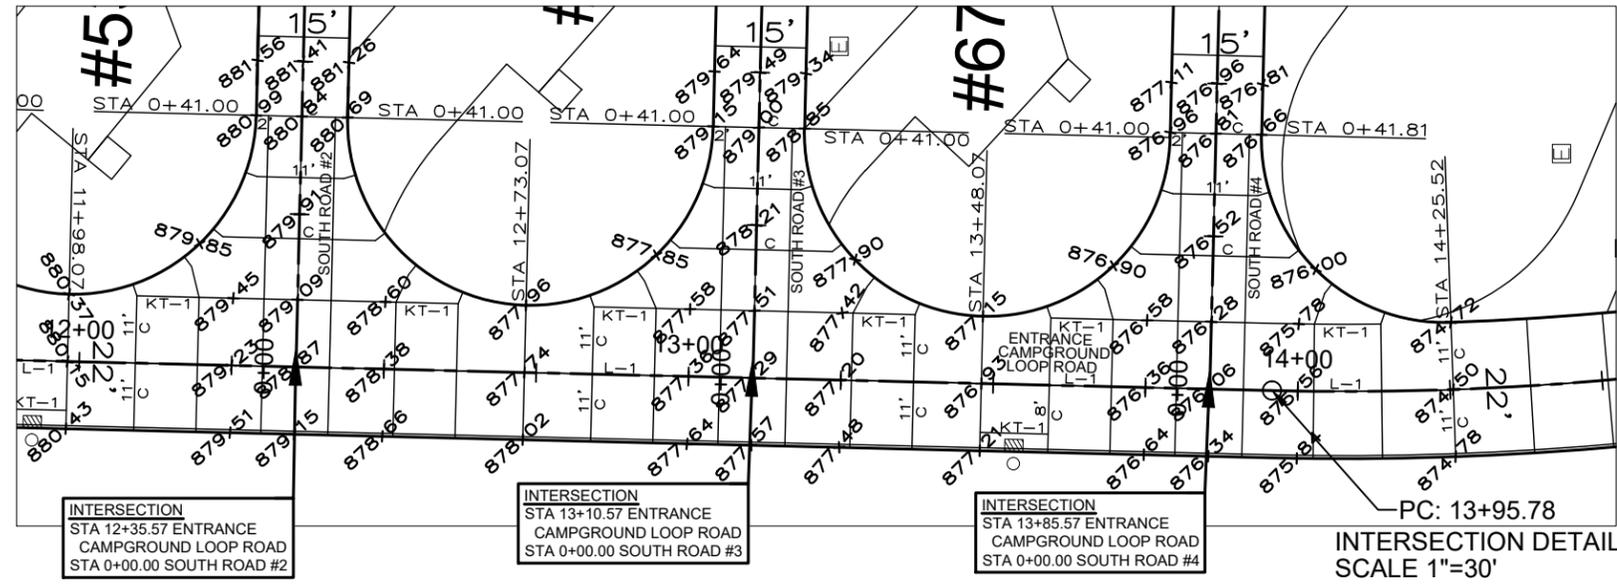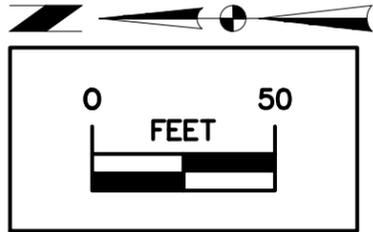

SEE SHEET #91 FOR ENTRANCE CAMPGROUND LOOP ROAD CROSS-SECTION DETAILS

SEE SHEET #86 FOR ENTRANCE CAMPGROUND LOOP ROAD CENTERLINE CONTROL

SEE SHEET #97 FOR ENTRANCE CAMPGROUND LOOP ROAD EDGE PROFILE PVI CONTROL

INTERSECTION STA 12+35.57 ENTRANCE CAMPGROUND LOOP ROAD STA 0+00.00 SOUTH ROAD #2

INTERSECTION STA 13+10.57 ENTRANCE CAMPGROUND LOOP ROAD STA 0+00.00 SOUTH ROAD #3

INTERSECTION STA 13+85.57 ENTRANCE CAMPGROUND LOOP ROAD STA 0+00.00 SOUTH ROAD #4


INTERSECTION DETAIL SCALE 1"=30'

SEE SHEET #92 FOR SOUTH ROAD #1 INFORMATION

SEE SHEET #93 FOR SOUTH ROAD #2 INFORMATION

SEE SHEETS #94-95 FOR SOUTH ROAD #3 INFORMATION


SEE SHEET #96 FOR SOUTH ROAD #4 INFORMATION

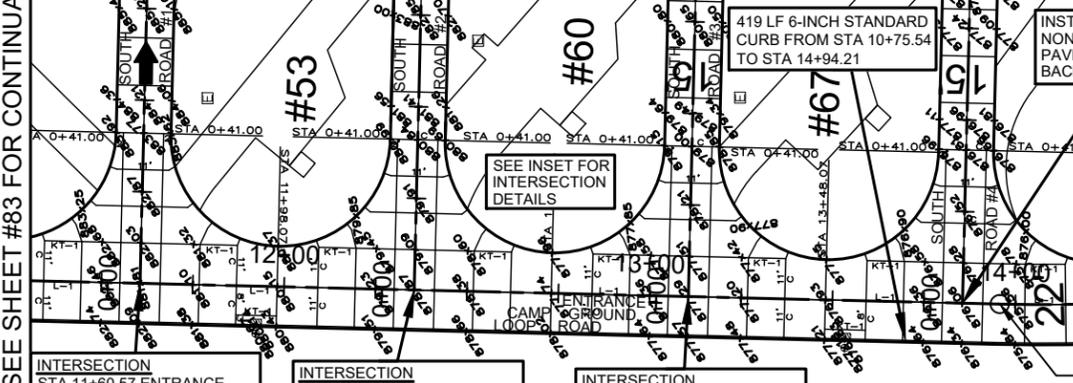

INTERSECTION STA 11+60.57 ENTRANCE CAMPGROUND LOOP ROAD STA 0+00.00 SOUTH ROAD #1

INTERSECTION STA 12+35.57 ENTRANCE CAMPGROUND LOOP ROAD STA 0+00.00 SOUTH ROAD #2

INTERSECTION STA 13+10.57 ENTRANCE CAMPGROUND LOOP ROAD STA 0+00.00 SOUTH ROAD #3

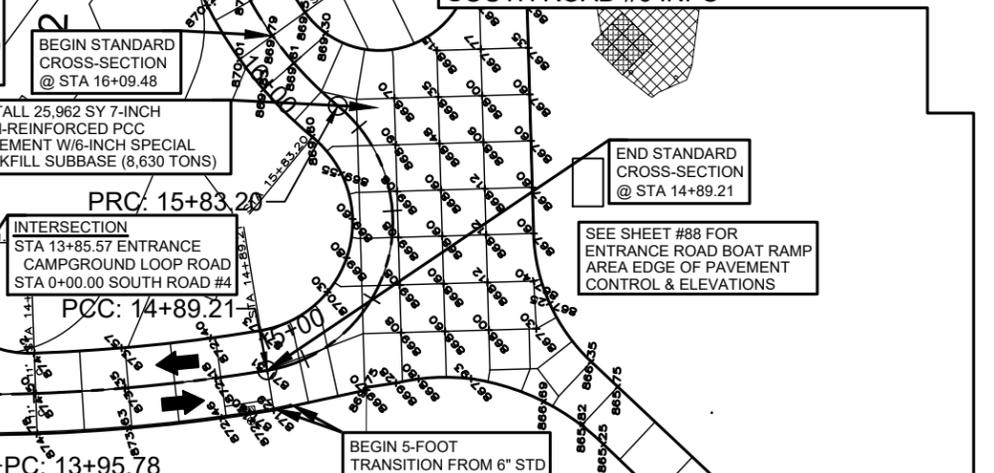

BEGIN STANDARD CROSS-SECTION @ STA 16+09.48


INSTALL 25,962 SY 7-INCH NON-REINFORCED PCC PAVEMENT W/6-INCH SPECIAL BACKFILL SUBBASE (8,630 TONS)

END STANDARD CROSS-SECTION @ STA 14+89.21

SEE SHEET #88 FOR ENTRANCE ROAD BOAT RAMP AREA EDGE OF PAVEMENT CONTROL & ELEVATIONS

BEGIN 5-FOOT TRANSITION FROM 6" STD CURB @ STA 14+89.21 TO NO CURB @ STA 14+94.21

PAINT BROKEN YELLOW ϵ 10' IN LENGTH SEPARATED BY 30' ALONG ENTRANCE CAMPGROUND LOOP ROAD FROM STA 0+00.00 TO STA 14+89.21, AND FROM STA 16+09.48 TO STA 22+02.20 (P&I BID ITEM). NOTE: PAINT STRIPING AND MARKINGS SHALL BE IN ACCORDANCE TO IDOT SECTION 4183 TRAFFIC PAINTS AND PAVEMENT MARKINGS.

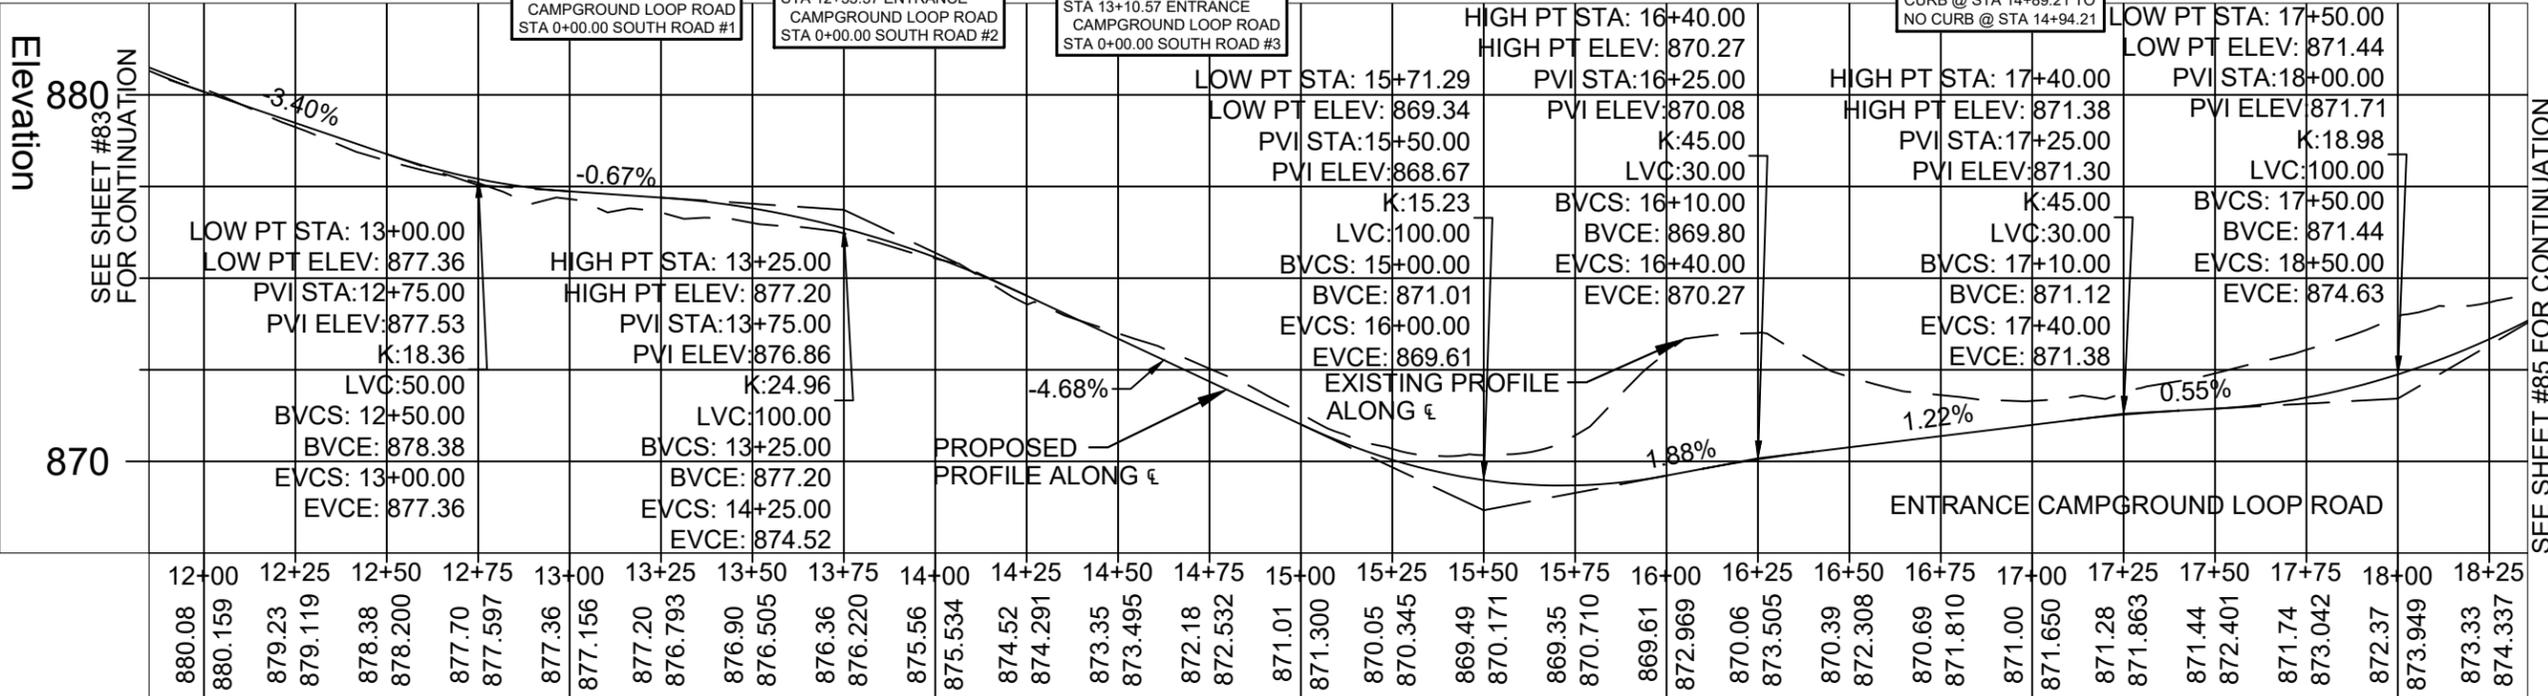

CONSULTANT:

IOWA DEPARTMENT OF NATURAL RESOURCES

ENGINEERING SERVICES - WALLACE BUILDING
502 E. 9TH ST., DES MOINES, IA 50319-0034

WARREN COUNTY, IOWA

CONSTRUCTION PROJECT FOR:
LAKE AHQUABI CAMPGROUND UPGRADE PROJECT

PAVING PLAN ENTRANCE ROAD

SEE SHEET #83 FOR CONTINUATION

SEE SHEET #85 FOR CONTINUATION

NO.	DATE	REVISION

DRAWN BY: PROJECT NUMBER: 22-05-91-01


CHECKED BY: DATE: 12/29/2021

SHEET No: **84**

ENTRANCE CAMPGROUND LOOP ROAD CENTERLINE CONTROL												
No.	Type	Length	Radius	Direction	Start Station	End Station	Delta angle	Chord length	Chord Direction	Start Point	End Point	Center Point
1	Curve	31.40'	185.00'		0+00.00'	0+31.40'	9.7249 (d)	31.36'	S54° 45' 26"W	(1615443.2012',472205.7418',902.78')	(1615417.5870',472187.6444',903.16')	(1615536.7625',472046.1445')
2	Curve	38.99'	211.00'		0+31.40'	0+70.39'	10.5886 (d)	38.94'	S55° 11' 21"W	(1615417.5870',472187.6444',903.16')	(1615385.6168',472165.4156',903.62')	(1615281.6625',472349.0307')
3	Line	85.63'		S60° 29' 01"W	0+70.39'	1+56.02'				(1615385.6168',472165.4156',903.62')	(1615311.1026',472123.2291',904.60')	
4	Curve	79.54'	250.00'		1+56.02'	2+35.56'	18.2290 (d)	79.20'	S69° 35' 53"W	(1615311.1026',472123.2291',904.60')	(1615236.8669',472095.6181',903.88')	(1615187.9339',472340.7825')
5	Curve	164.80'	400.00'		2+35.56'	4+00.36'	23.6052 (d)	163.63'	N89° 29' 06"W	(1615236.8669',472095.6181',903.88')	(1615073.2412',472097.0892',899.21')	(1615158.5741',472487.8811')
6	Line	357.68'		N77° 40' 56"W	4+00.36'	7+58.04'				(1615073.2412',472097.0892',899.21')	(1614723.7936',472173.3942',897.56')	
7	Curve	43.00'	200.00'		7+58.04'	8+01.03'	12.3177 (d)	42.91'	N83° 50' 28"W	(1614723.7936',472173.3942',897.56')	(1614681.1271',472177.9983',897.08')	(1614681.1271',471977.9983')
8	Line	47.02'		N90° 00' 00"W	8+01.03'	8+48.05'				(1614681.1271',472177.9983',897.08')	(1614634.1084',472177.9983',896.33')	
9	Curve	35.71'	175.00'		8+48.05'	8+83.76'	11.6919 (d)	35.65'	N84° 09' 15"W	(1614634.1084',472177.9983',896.33')	(1614598.6449',472181.6292',895.75')	(1614634.1084',472352.9983')
10	Line	13.84'		N78° 18' 29"W	8+83.76'	8+97.60'				(1614598.6449',472181.6292',895.75')	(1614585.0955',472184.4332',895.46')	
11	Curve	35.71'	175.00'		8+97.60'	9+33.31'	11.6919 (d)	35.65'	N84° 09' 15"W	(1614585.0955',472184.4332',895.46')	(1614549.6320',472188.0642',894.45')	(1614549.6320',472013.0642')
12	Line	41.70'		N90° 00' 00"W	9+33.31'	9+75.01'				(1614549.6320',472188.0642',894.45')	(1614507.9358',472188.0642',892.79')	
13	Curve	100.54'	65.00'		9+75.01'	10+75.54'	88.6203 (d)	90.81'	S45° 41' 23"W	(1614507.9358',472188.0642',892.79')	(1614442.9546',472124.6292',887.02')	(1614507.9358',472123.0642')
14	Line	320.23'		S1° 22' 47"W	10+75.54'	13+95.78'				(1614442.9546',472124.6292',887.02')	(1614435.2441',471804.4891',875.72')	
15	Curve	93.43'	500.00'		13+95.78'	14+89.21'	10.7065 (d)	93.30'	S3° 58' 25"E	(1614435.2441',471804.4891',875.72')	(1614441.7092',471711.4172',871.51')	(1614935.0992',471792.4502')
16	Curve	93.99'	41.00'		14+89.21'	15+83.20'	131.3441 (d)	74.72'	S74° 59' 56"E	(1614441.7092',471711.4172',871.51')	(1614513.8815',471692.0772',869.39')	(1614482.1672',471718.0619')
17	Curve	82.12'	100.00'		15+83.20'	16+65.32'	47.0529 (d)	79.83'	N62° 51' 20"E	(1614513.8815',471692.0772',869.39')	(1614584.9230',471728.5007',870.57')	(1614591.2335',471628.7000')
18	Line	78.56'		N86° 22' 55"E	16+65.32'	17+43.88'				(1614584.9230',471728.5007',870.57')	(1614663.3311',471733.4585',871.41')	
19	Curve	185.54'	100.00'		17+43.88'	19+29.43'	106.3075 (d)	160.05'	N33° 13' 42"E	(1614663.3311',471733.4585',871.41')	(1614751.0342',471867.3391',879.25')	(1614657.0206',471833.2592')
20	Line	210.67'		N19° 55' 32"W	19+29.43'	21+40.10'				(1614751.0342',471867.3391',879.25')	(1614679.2373',472065.3998',891.18')	
21	Curve	26.08'	75.00'		21+40.10'	21+66.18'	19.9256 (d)	25.95'	N9° 57' 46"W	(1614679.2373',472065.3998',891.18')	(1614674.7475',472090.9597',892.35')	(1614749.7475',472090.9597')
22	Line	87.04'		N0° 00' 00"W	21+66.18'	22+53.22'				(1614674.7475',472090.9597',892.35')	(1614674.7475',472177.9983',896.98')	

OUTSIDE EDGE OF SOUTH SHOWER PARKING AREA												
No.	Type	Length	Radius	Direction	Start Station	End Station	Delta angle	Chord length	Chord Direction	Start Point	End Point	Center Point
1	Line	2.00'		N57° 38' 11"W	0+00.00'	0+02.00'				(1614660.4314',472057.2952',891.50')	(1614658.7420',472058.3658',891.60')	
2	Curve	10.53'	5.00'		0+02.00'	0+12.53'	120.7064 (d)	8.69'	N27° 59' 23"W	(1614658.7420',472058.3658',891.60')	(1614654.6633',472066.0401',891.90')	(1614654.5187',472061.0422')
3	Line	18.27'		N88° 20' 35"W	0+12.53'	0+30.80'				(1614654.6633',472066.0401',891.90')	(1614636.4053',472066.5683',892.00')	
4	Line	35.00'		N1° 39' 25"E	0+30.80'	0+65.80'				(1614636.4053',472066.5683',892.00')	(1614637.4174',472101.5537',892.40')	
5	Line	19.19'		S88° 20' 35"E	0+65.80'	0+84.99'				(1614637.4174',472101.5537',892.40')	(1614656.6037',472100.9986',892.95')	
6	Curve	7.94'	5.00'		0+84.99'	0+92.93'	90.9943 (d)	7.13'	N46° 09' 36"E	(1614656.6037',472100.9986',892.95')	(1614661.7480',472105.9387',893.25')	(1614656.7483',472105.9965')
7	Line	2.00'		N90° 00' 00"E	0+92.93'	0+94.93'				(1614661.7480',472105.9387',893.25')	(1614663.7475',472105.9387',893.27')	
8	Line	14.98'		S0° 00' 00"E	0+94.93'	1+09.91'				(1614663.7475',472105.9387',893.27')	(1614663.7475',472090.9597',892.06')	
9	Curve	13.10'	86.00'		1+09.91'	1+23.02'	8.7298 (d)	13.09'	S4° 21' 54"E	(1614663.7475',472090.9597',892.06')	(1614664.7438',472077.9071',891.68')	(1614749.7475',472090.9597')
10	Curve	21.52'	30.00'		1+23.02'	1+44.53'	41.0933 (d)	21.06'	S11° 49' 01"W	(1614664.7438',472077.9071',891.68')	(1614660.4314',472057.2952',891.50')	(1614635.0913',472073.3538')

CONSULTANT:

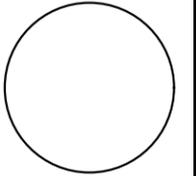

IOWA DEPARTMENT OF
NATURAL RESOURCES

ENGINEERING SERVICES - WALLACE BUILDING
502 E. 9TH ST., DES MOINES, IA 50319-0034



PAVING PLAN ENTRANCE ROAD

CONSTRUCTION PROJECT FOR:

LAKE AHQUABI CAMPGROUND
UPGRADE PROJECT

WARREN COUNTY, IOWA

NO. BY DATE REVISION

DRAWN BY: PROJECT NUMBER:

22-05-91-01

CHKD BY: DATE:

12/29/2021

SHEET No:


86

LEGEND


EXISTING/PROPOSED

- MANHOLE
- INTAKE
- ⊕ HYDRANT
- ⊗ VALVE
- ⊞ OUTLET POST
- PPI/LP
- PPI/LP
- MANHOLE
- ▨ INTAKE
- ⊕ HYDRANT
- ⊗ VALVE
- ⊞ OUTLET POST
- PPI/LP
- PPI/LP
- POWER POLE/ LIGHT POLE

SEE SHEETS #102-110 FOR NORTH LOOP CAMPGROUND ROAD INFO

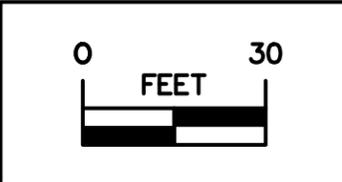

SEE SHEETS #82-91 FOR ENTRANCE CAMPGROUND LOOP ROAD INFO

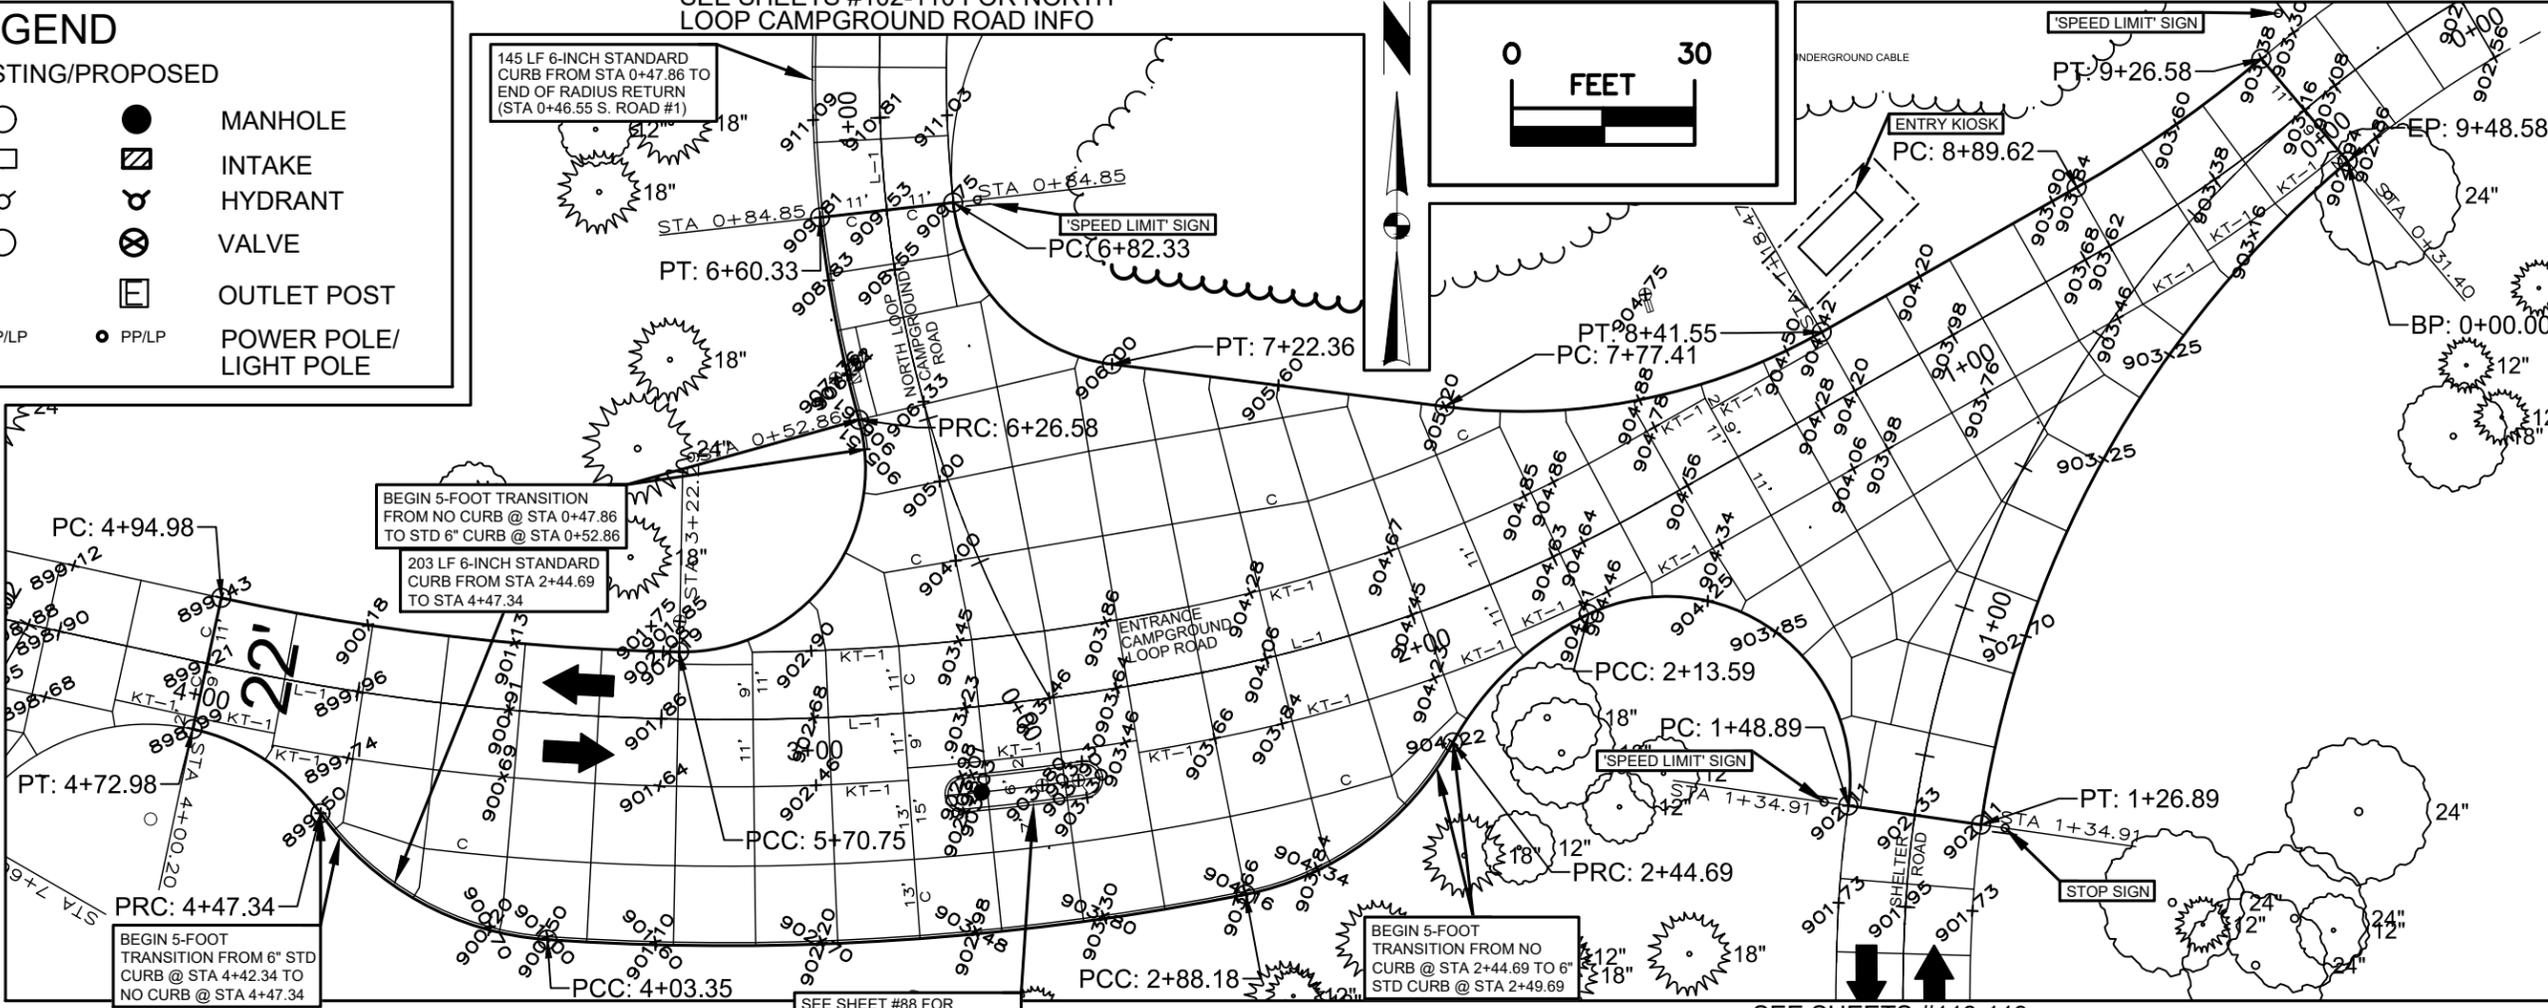


SEE SHEET #88 FOR DISPOSAL STATION DETAILS

SEE SHEETS #118-119 FOR SHELTER ROAD INFO

ENTRANCE ROAD EDGE OF PAVEMENT ALIGNMENT												
No.	Type	Length	Radius	Direction	Start Station	End Station	Delta angle	Chord length	Chord Direction	Start Point	End Point	Center Point
1	Curve	126.89'	174.00'		0+00.00'	1+26.89'	41.7815 (d)	124.09'	S29° 00' 15"W	(1615424.6731', 472179.2309', 902.94')	(1615364.5041', 472070.7016', 902.11')	(1615536.7625', 472046.1445')
2	Line	22.00'		N81° 53' 12"W	1+26.89'	1+48.89'				(1615364.5041', 472070.7016', 902.11')	(1615342.7243', 472073.8065', 902.11')	
3	Curve	64.70'	30.00'		1+48.89'	2+13.59'	123.5724 (d)	52.87'	N53° 40' 22"W	(1615342.7243', 472073.8065', 902.11')	(1615300.1286', 472105.1273', 904.41')	(1615313.0246', 472078.0405')
4	Curve	31.10'	50.00'		2+13.59'	2+44.69'	35.6362 (d)	30.60'	S46° 43' 23"W	(1615300.1286', 472105.1273', 904.41')	(1615277.8507', 472084.1505', 904.22')	(1615321.6219', 472059.9827')
5	Curve	43.50'	50.00'		2+44.69'	2+88.18'	49.8444 (d)	42.14'	S53° 49' 37"W	(1615277.8507', 472084.1505', 904.22')	(1615243.8347', 472059.2791', 904.16')	(1615234.0795', 472108.3182')
6	Curve	115.17'	437.00'		2+88.18'	4+03.35'	15.0995 (d)	114.83'	S86° 17' 56"W	(1615243.8347', 472059.2791', 904.16')	(1615129.2418', 472051.8666', 901.00')	(1615158.5741', 472487.8811')
7	Curve	44.00'	50.00'		4+03.35'	4+47.34'	50.4159 (d)	42.59'	N60° 56' 36"W	(1615129.2418', 472051.8666', 901.00')	(1615092.0118', 472072.5517', 899.50')	(1615132.5979', 472101.7538')
8	Curve	25.64'	35.00'		4+47.34'	4+72.98'	41.9697 (d)	25.07'	N56° 43' 13"W	(1615092.0118', 472072.5517', 899.50')	(1615071.0545', 472086.3075', 898.99')	(1615063.6015', 472052.1102')
9	Line	22.00'		N12° 17' 42"E	4+72.98'	4+94.98'				(1615071.0545', 472086.3075', 898.99')	(1615075.7392', 472107.8029', 899.43')	
10	Curve	75.76'	389.00'		4+94.98'	5+70.75'	11.1593 (d)	75.64'	S83° 17' 05"E	(1615075.7392', 472107.8029', 899.43')	(1615150.8649', 472098.9575', 902.19')	(1615158.5741', 472487.8811')
11	Curve	55.83'	30.00'		5+70.75'	6+26.58'	106.6289 (d)	48.12'	N37° 49' 16"E	(1615150.8649', 472098.9575', 902.19')	(1615180.3693', 472136.9654', 906.61')	(1615151.4594', 472128.9516')
12	Curve	33.76'	211.00'		6+26.58'	6+60.33'	9.1665 (d)	33.72'	N10° 54' 36"W	(1615180.3693', 472136.9654', 906.61')	(1615173.9869', 472170.0768', 909.81')	(1615383.7018', 472193.3292')
13	Line	22.00'		N83° 40' 23"E	6+60.33'	6+82.33'				(1615173.9869', 472170.0768', 909.81')	(1615195.8529', 472172.5012', 909.75')	
14	Curve	40.03'	30.00'		6+82.33'	7+22.36'	76.4440 (d)	37.12'	S44° 32' 56"E	(1615195.8529', 472172.5012', 909.75')	(1615221.8951', 472146.0457', 906.00')	(1615225.6702', 472175.8072')
15	Line	55.05'		S82° 46' 15"E	7+22.36'	7+77.41'				(1615221.8951', 472146.0457', 906.00')	(1615276.5093', 472139.1181', 905.20')	
16	Curve	64.13'	100.00'		7+77.41'	8+41.55'	36.7457 (d)	63.04'	N78° 51' 23"E	(1615276.5093', 472139.1181', 905.20')	(1615338.3605', 472151.3018', 904.42')	(1615289.0931', 472238.3232')
17	Line	48.08'		N60° 29' 01"E	8+41.55'	8+89.62'				(1615338.3605', 472151.3018', 904.42')	(1615380.1974', 472174.9879', 903.84')	
18	Curve	36.96'	200.00'		8+89.62'	9+26.58'	10.5886 (d)	36.91'	N55° 11' 21"E	(1615380.1974', 472174.9879', 903.84')	(1615410.5009', 472196.0579', 903.38')	(1615281.6625', 472349.0307')
19	Line	22.00'		S40° 06' 18"E	9+26.58'	9+48.58'				(1615410.5009', 472196.0579', 903.38')	(1615424.6731', 472179.2309', 902.94')	

CONSULTANT:

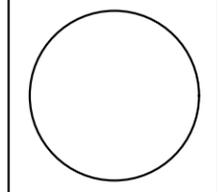

IOWA DEPARTMENT OF NATURAL RESOURCES
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 502 E. 9TH ST., DES MOINES, IA 50319-0034




PAVING PLAN ENTRANCE ROAD EDGE

CONSTRUCTION PROJECT FOR:
LAKE AHQUABI CAMPGROUND UPGRADE PROJECT
 WARREN COUNTY, IOWA

NO.	DATE	REVISION



DRAWN BY: PROJECT NUMBER: 22-05-91-01
 CHKD BY: DATE: 12/29/2021
 SHEET NO:

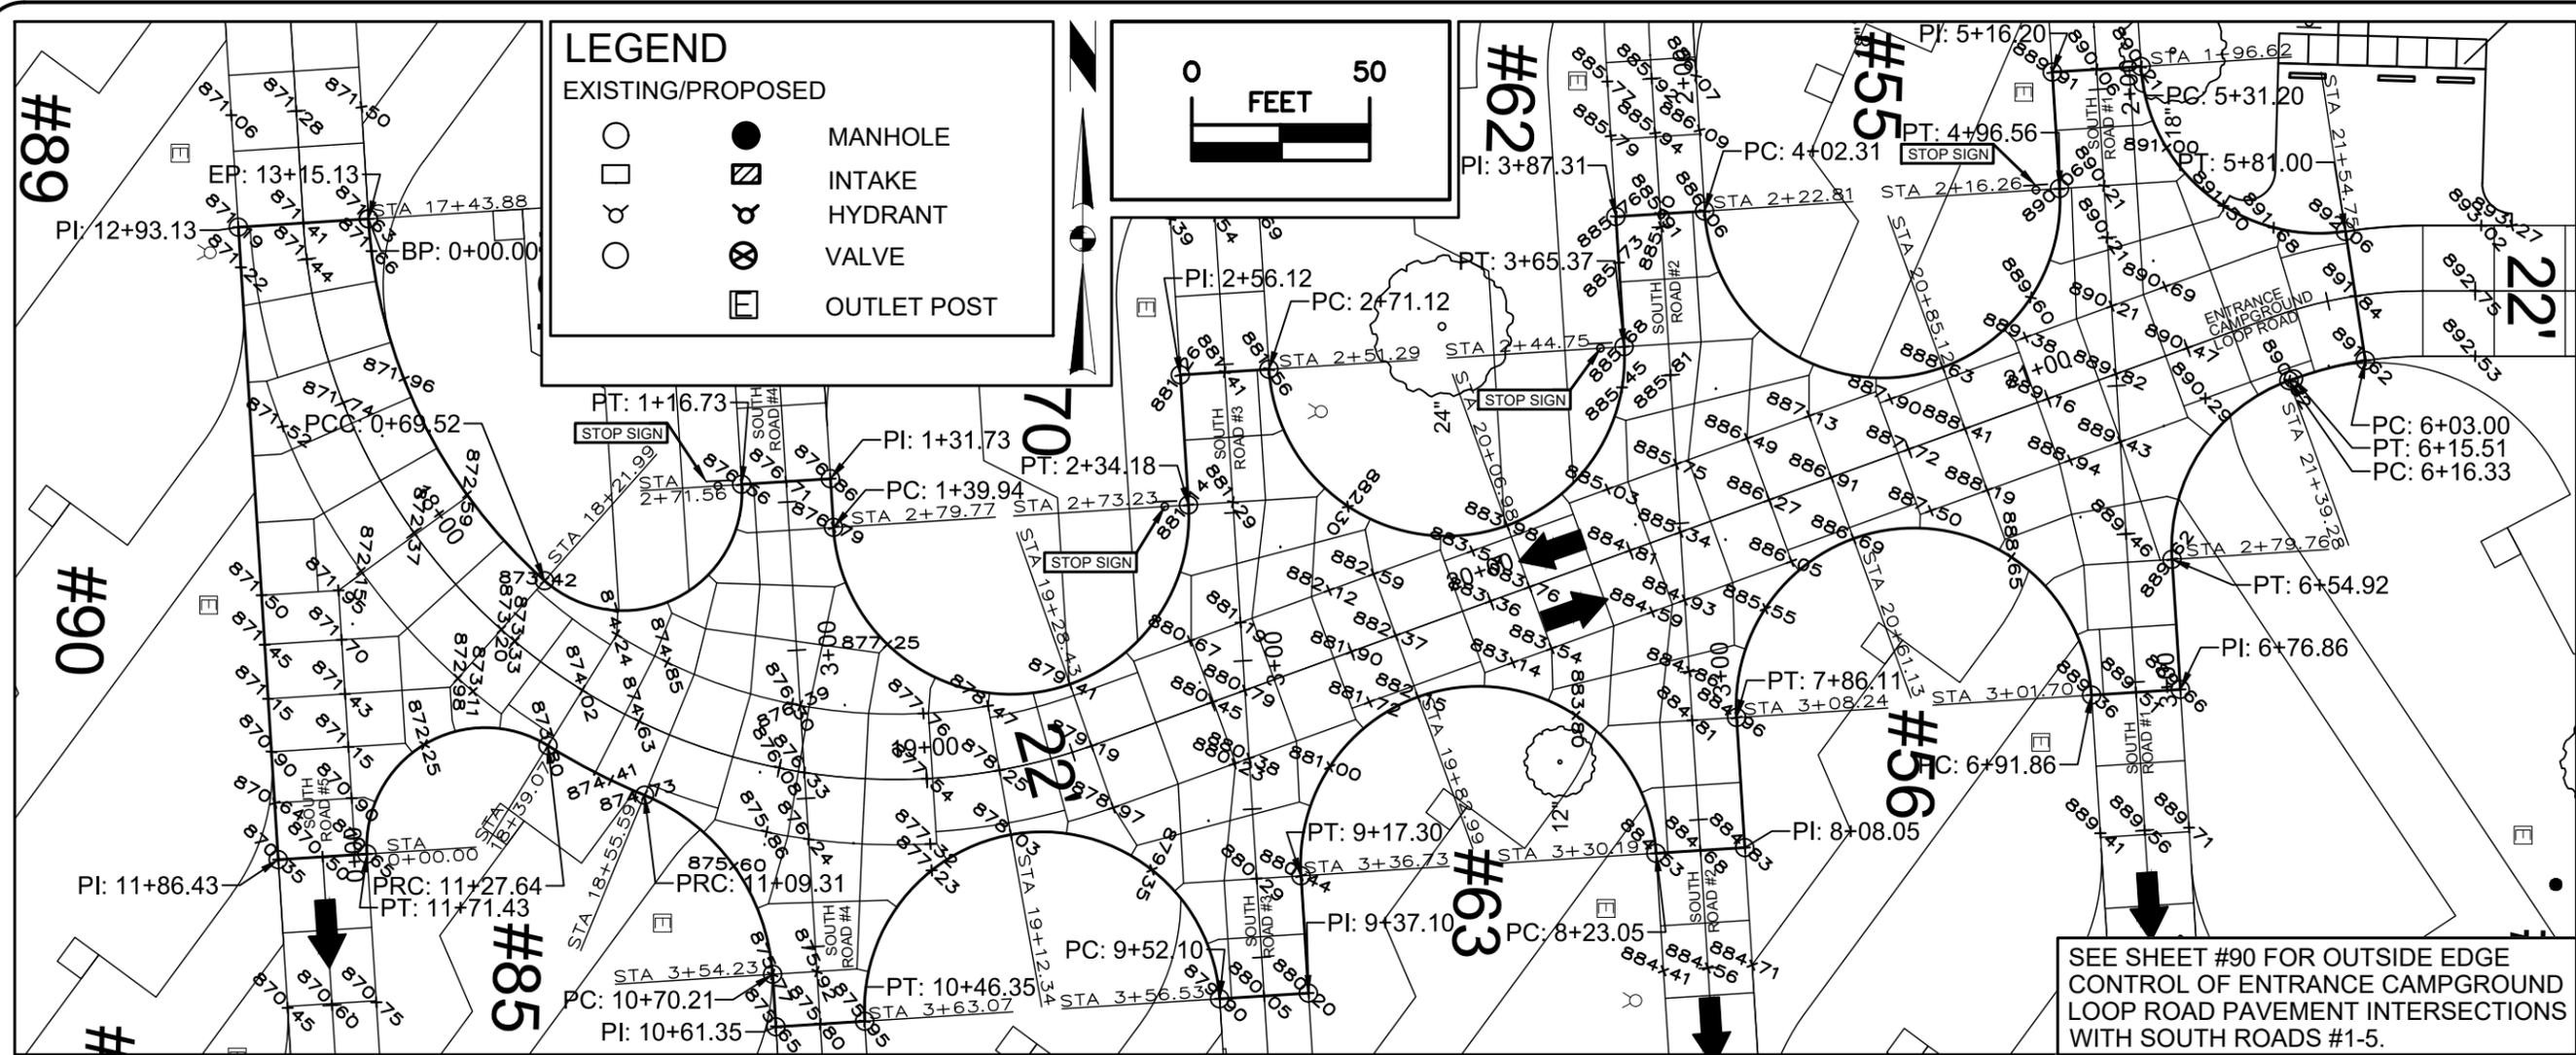

CONSULTANT:

IOWA DEPARTMENT OF NATURAL RESOURCES
 ENGINEERING SERVICES - WALLACE BUILDING
 502 E. 9TH ST., DES MOINES, IA 50319-0034

SEE SHEET #90 FOR OUTSIDE EDGE CONTROL OF ENTRANCE CAMPGROUND LOOP ROAD PAVEMENT INTERSECTIONS WITH SOUTH ROADS #1-5.

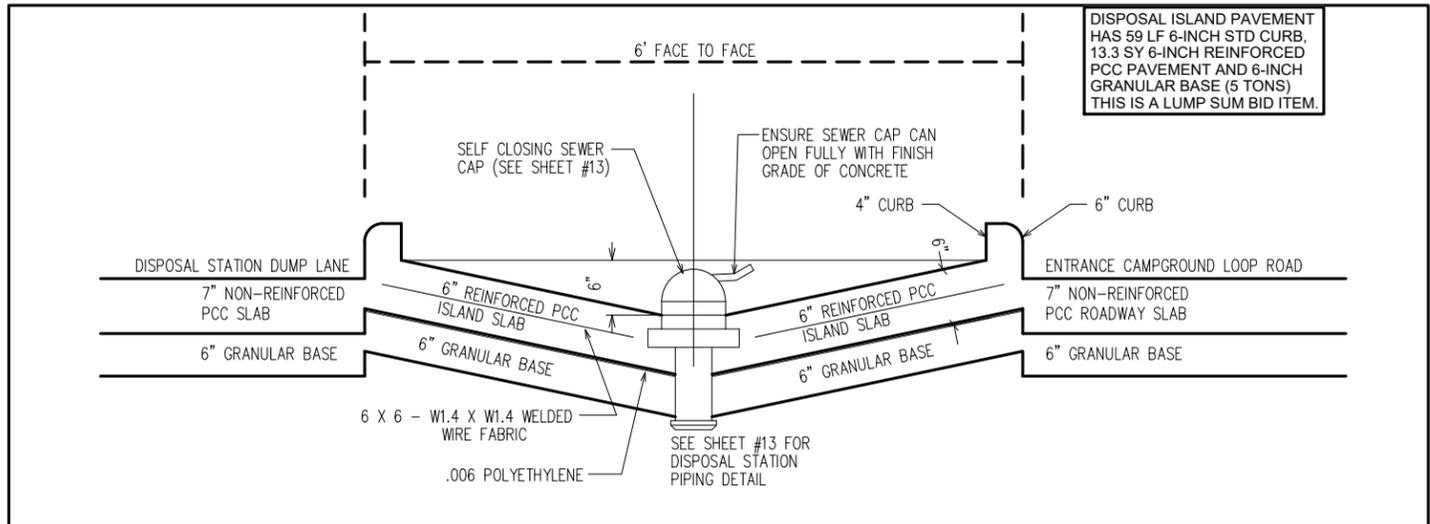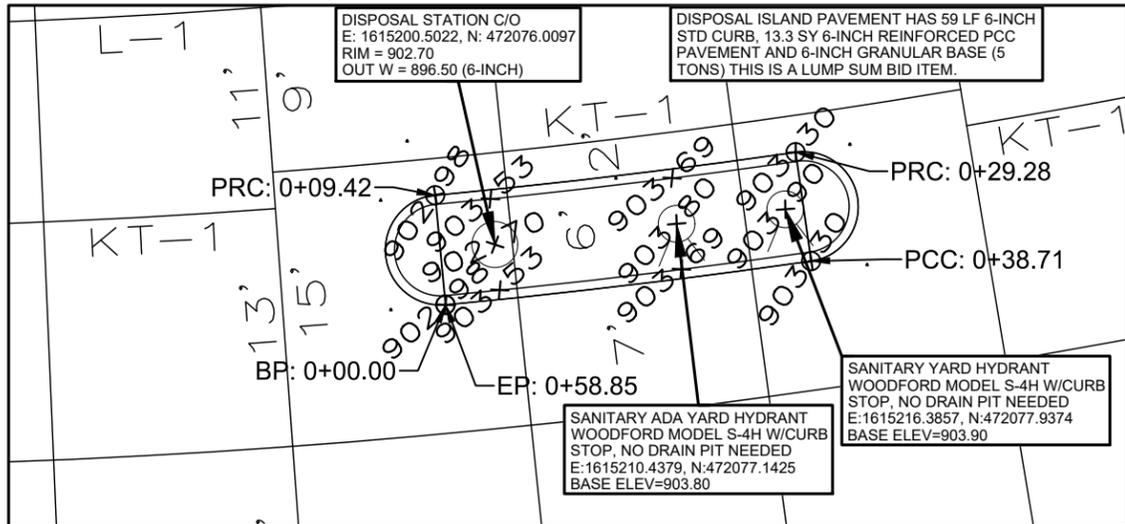

DISPOSAL ISLAND DETAILS SCALE: 1"=10'

DISPOSAL ISLAND CROSS SECTION LOOKING WEST

OUTSIDE EDGE OF DISOPOSAL ISLAND PAVEMENT ALIGNMENT											
No.	Type	Length	Radius	Start Sta	End Sta	Delta angle	Ch length	Ch Direction	Start Point	End Point	Center Point
1	Curve	20.15'	417.00'	0+00.00'	0+20.15'	2.7680 (d)	20.14'	N83° 13' 07"E	(1615197.7988', 472072.7300', 902.98')	(1615217.8013', 472075.1086', 903.30')	(1615158.5741', 472487.8811')
2	Curve	9.42'	3.00'	0+20.15'	0+29.57'	180.0000 (d)	6.00'	N8° 09' 56"W	(1615217.8013', 472075.1086', 903.30')	(1615216.9491', 472081.0477', 903.30')	(1615217.3752', 472078.0782')
3	Curve	19.86'	411.00'	0+29.57'	0+49.43'	2.7680 (d)	19.85'	S83° 13' 07"W	(1615216.9491', 472081.0477', 903.30')	(1615197.2344', 472078.7034', 902.98')	(1615158.5741', 472487.8811')
4	Curve	9.42'	3.00'	0+49.43'	0+58.85'	180.0000 (d)	6.00'	S5° 23' 51"E	(1615197.2344', 472078.7034', 902.98')	(1615197.7988', 472072.7300', 902.98')	(1615197.5166', 472075.7167')

ENT ROAD PVMT EDGE & DISP ISLAND

CONSTRUCTION PROJECT FOR:
LAKE AHQUABI CAMPGROUND UPGRADE PROJECT

WARREN COUNTY, IOWA


NO. BY DATE REVISION

DRAWN BY: PROJECT NUMBER: 22-05-91-01

CHKD BY: DATE: 12/29/2021

SHEET No: **89**



SEE SHEET #83 FOR ENTRANCE ROAD INFO

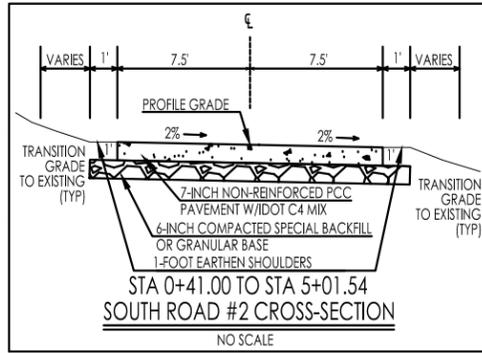

LEGEND


EXISTING/PROPOSED

- MANHOLE
- ◻ INTAKE
- ⊕ HYDRANT
- ⊗ VALVE
- OUTLET POST
- PP/LP POWER POLE/LIGHT POLE

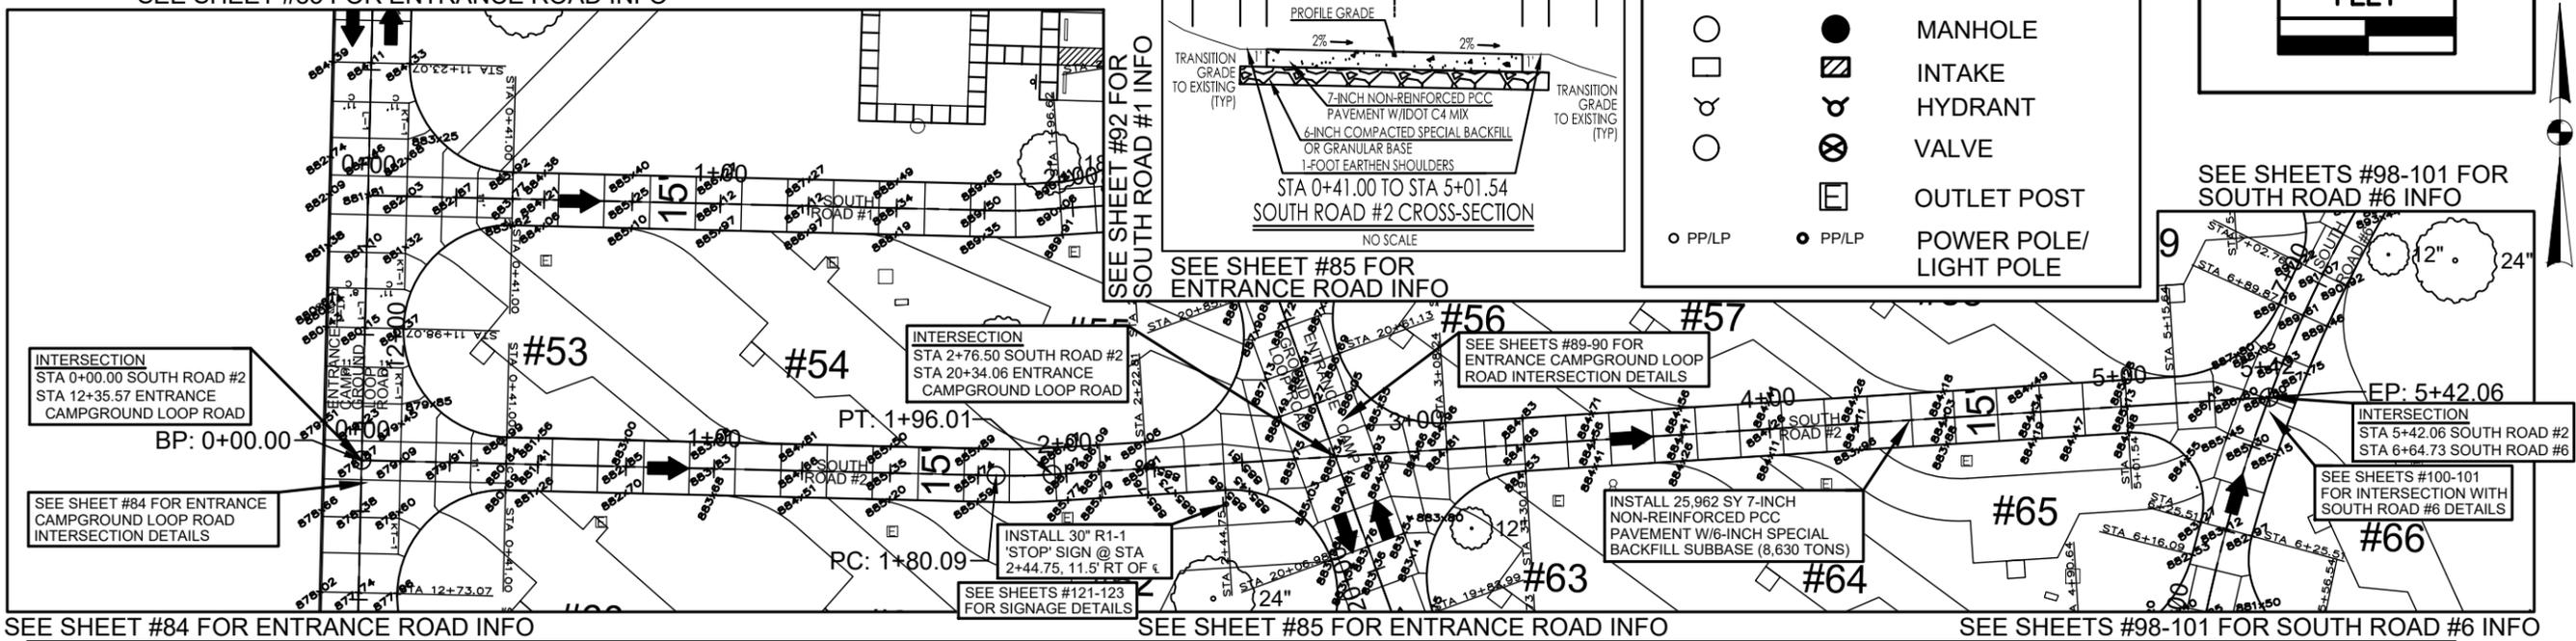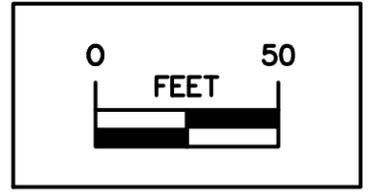

SEE SHEET #84 FOR ENTRANCE ROAD INFO SEE SHEET #85 FOR ENTRANCE ROAD INFO SEE SHEETS #98-101 FOR SOUTH ROAD #6 INFO

No.	Type	Length	Radius	Direction	Start Station	End Station	Delta angle	Chord length	Chord Direction	Start Point	End Point	Center Point
1	Line	180.09'		S88° 37' 13"E	0+00.00'	1+80.09'				(1614439.1016', 471964.6520', 878.87')	(1614619.1409', 471960.3158', 885.79')	
2	Curve	15.92'	182.50'		1+80.09'	1+96.01'	4.9977 (d)	15.91'	N88° 52' 51"E	(1614619.1409', 471960.3158', 885.79')	(1614635.0517', 471960.6267', 885.91')	(1614623.5351', 472142.7629')
3	Line	346.04'		N86° 22' 55"E	1+96.01'	5+42.06'				(1614635.0517', 471960.6267', 885.91')	(1614980.4068', 471982.4637', 886.80')	

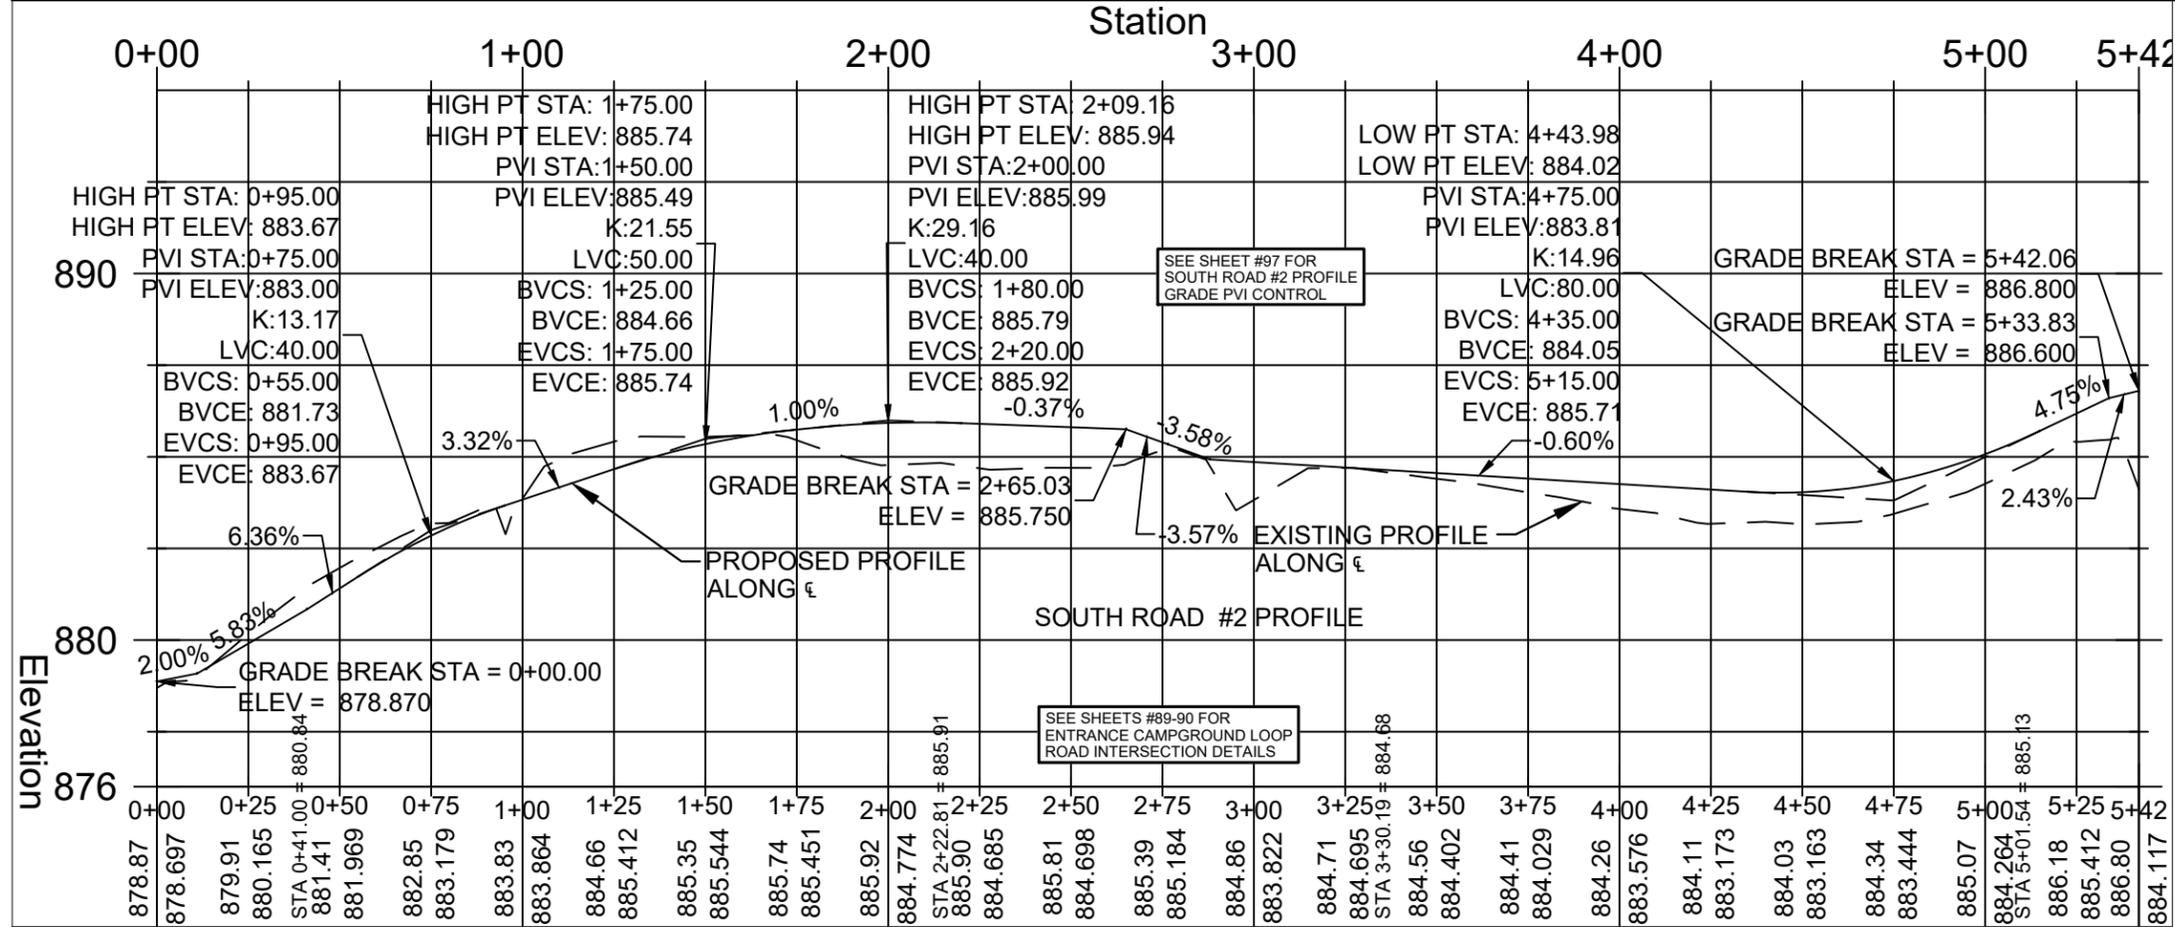

CONSULTANT:

IOWA DEPARTMENT OF NATURAL RESOURCES

ENGINEERING SERVICES - WALLACE BUILDING
502 E. 9TH ST., DES MOINES, IA 50319-0034



PAVING PLAN SOUTH ROAD #2

CONSTRUCTION PROJECT FOR:

LAKE AHQUABI CAMPGROUND UPGRADE PROJECT

WARREN COUNTY, IOWA

NO.	DATE	REVISION

DRAWN BY: PROJECT NUMBER: 22-05-91-01

CHKD BY: DATE: 12/29/2021




SHEET NO: **93**

SEE SHEET #82 FOR ENTRANCE ROAD INFO

LEGEND


EXISTING/PROPOSED

		MANHOLE
		INTAKE
		HYDRANT
		VALVE
		OUTLET POST
		POWER POLE/ LIGHT POLE

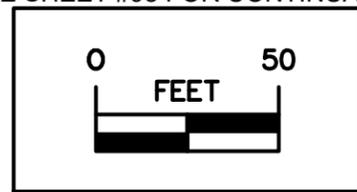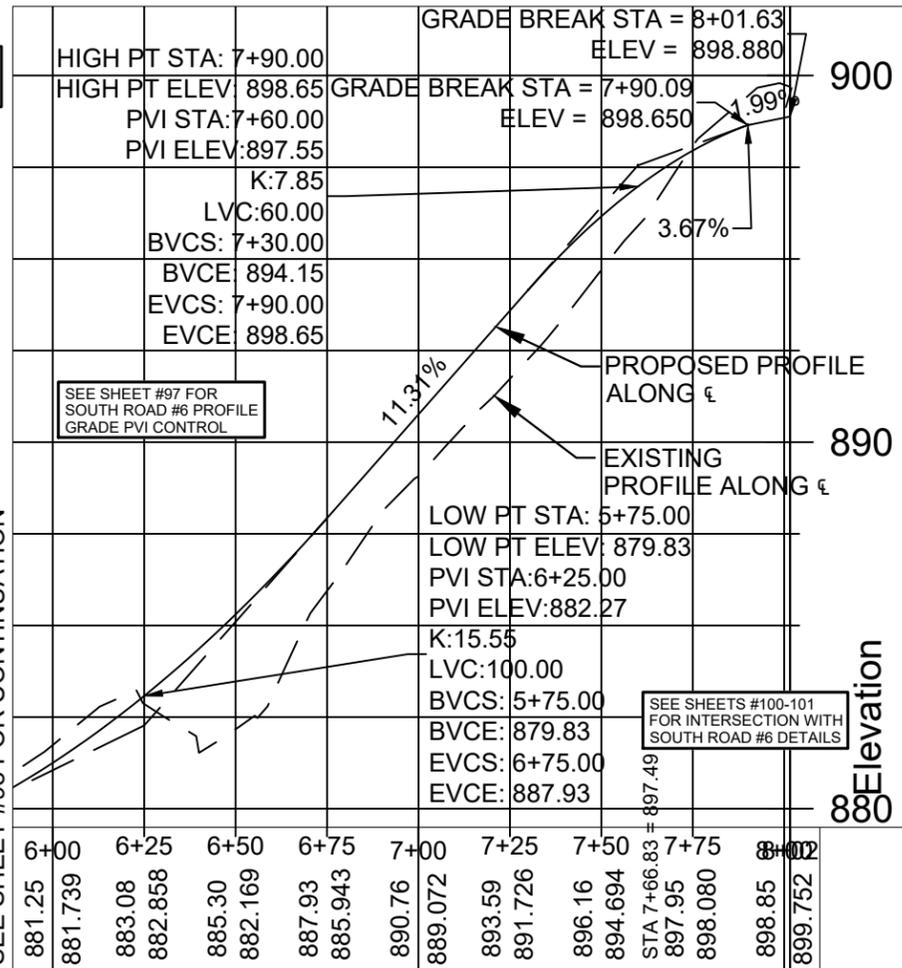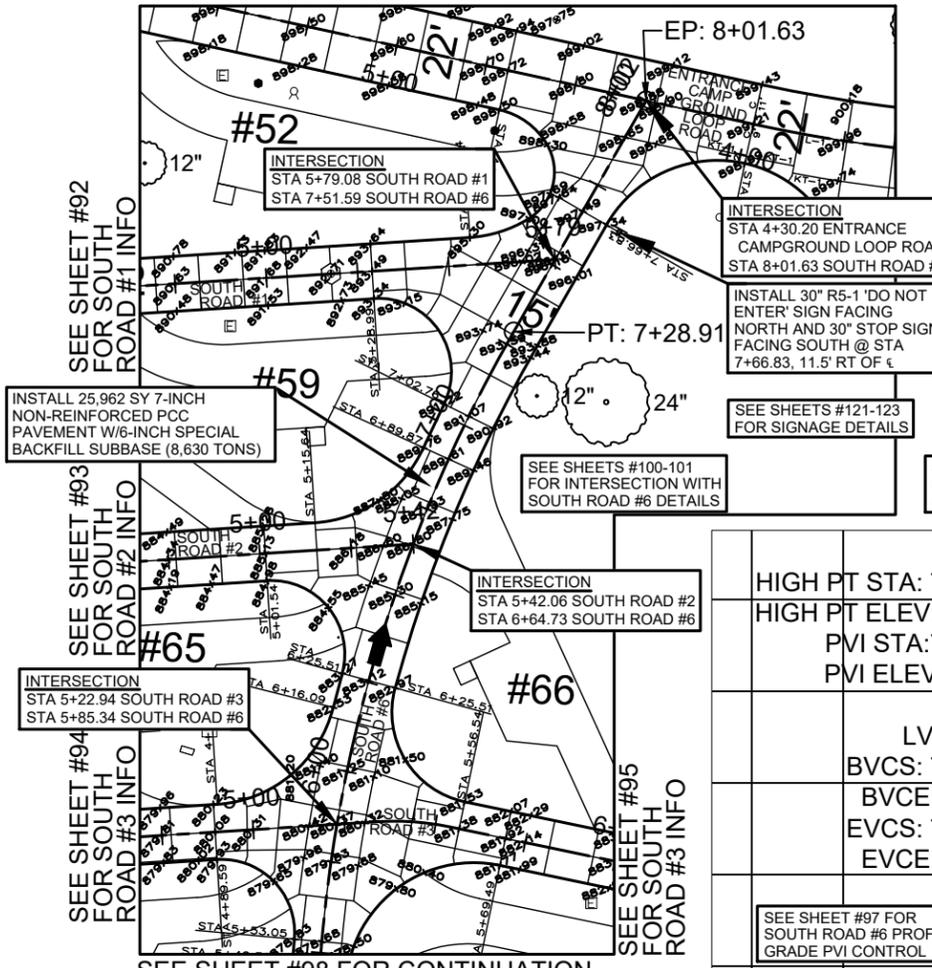

SOUTH CAMPGROUND ROAD #6												
No.	Type	Length	Radius	Direction	Start Station	End Station	Delta angle	Chord length	Chord Direction	Start Point	End Point	Center Point
1	Line	5.17'		N88° 21' 15"E	0+00.00'	0+05.17'				(1614554.8977', 471648.2423', 867.00')	(1614560.0638', 471648.3907', 866.95')	
2	Curve	6.88'	200.00'		0+05.17'	0+12.05'	1.9721 (d)	6.88'	N87° 22' 05"E	(1614560.0638', 471648.3907', 866.95')	(1614566.9401', 471648.7068', 866.88')	(1614554.3191', 471848.3082')
3	Line	291.95'		N86° 22' 55"E	0+12.05'	3+04.00'				(1614566.9401', 471648.7068', 866.88')	(1614858.3073', 471667.1302', 867.63')	
4	Curve	91.37'	77.50'		3+04.00'	3+95.37'	67.5479 (d)	86.17'	N52° 36' 29"E	(1614858.3073', 471667.1302', 867.63')	(1614926.7671', 471719.4566', 868.94')	(1614853.4166', 471744.4757')
5	Curve	144.48'	532.50'		3+95.37'	5+39.85'	15.5461 (d)	144.04'	N11° 03' 40"E	(1614926.7671', 471719.4566', 868.94')	(1614954.4018', 471860.8213', 877.91')	(1614422.7784', 471891.3624')
6	Curve	189.06'	407.50'		5+39.85'	7+28.91'	26.5819 (d)	187.37'	N16° 34' 44"E	(1614954.4018', 471860.8213', 877.91')	(1615007.8638', 472040.3972', 894.03')	(1615361.2310', 471837.4494')
7	Line	72.72'		N29° 52' 11"E	7+28.91'	8+01.63'				(1615007.8638', 472040.3972', 894.03')	(1615044.0804', 472103.4567', 898.88')	

CONSULTANT:

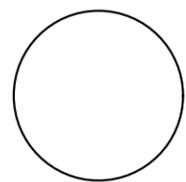

IOWA DEPARTMENT OF NATURAL RESOURCES
 ENGINEERING SERVICES - WALLACE BUILDING
 502 E. 9TH ST., DES MOINES, IA 50319-0034



PAVING PLAN SOUTH ROAD #6

CONSTRUCTION PROJECT FOR:
LAKE AHQUABI CAMPGROUND UPGRADE PROJECT
 WARREN COUNTY, IOWA

NO.	BY DATE	REVISION


DRAWN BY: PROJECT NUMBER:
 22-05-91-01

CHKD BY: DATE:
 12/29/2021

SHEET No:

OUTSIDE EDGE OF NORTH LOOP ROAD PAVEMENT INTERSECTIONS WITH NORTH ROADS #2-7 WEST SIDE												
No.	Type	Length	Radius	Direction	Start Station	End Station	Delta angle	Chord length	Chord Direction	Start Point	End Point	Center Point
1	Curve	37.06'	75.00'		0+00.00'	0+37.06'	28.3095 (d)	36.68'	S75° 20' 30"W	(1615006.8381',472827.7253',946.03')	(1614971.3507',472818.4430',944.71')	(1615007.4972',472752.7282')
2	Curve	62.45'	25.00'		0+37.06'	0+99.51'	143.1301 (d)	47.43'	S10° 22' 41"E	(1614971.3507',472818.4430',944.71')	(1614979.8957',472771.7848',944.20')	(1614983.3996',472796.5381')
3	Line	15.00'		S8° 03' 25"W	0+99.51'	1+14.51'				(1614979.8957',472771.7848',944.20')	(1614977.7934',472756.9329',943.90')	
4	Line	14.08'		N81° 56' 35"W	1+14.51'	1+28.59'				(1614977.7934',472756.9329',943.90')	(1614963.8499',472758.9066',943.32')	
5	Curve	94.25'	30.00'		1+28.59'	2+22.84'	180.0000 (d)	60.00'	S8° 03' 25"W	(1614963.8499',472758.9066',943.32')	(1614955.4406',472699.4988',939.27')	(1614959.6452',472729.2027')
6	Line	2.35'		S81° 56' 35"E	2+22.84'	2+25.19'				(1614955.4406',472699.4988',939.27')	(1614957.7663',472699.1696',939.37')	
7	Line	15.00'		S8° 03' 25"W	2+25.19'	2+40.19'				(1614957.7663',472699.1696',939.37')	(1614955.6640',472684.3177',939.07')	
8	Curve	94.25'	30.00'		2+40.19'	3+34.44'	180.0000 (d)	60.00'	S8° 03' 25"W	(1614955.6640',472684.3177',939.07')	(1614947.2547',472624.9099',933.26')	(1614951.4593',472654.6138')
9	Line	2.35'		S81° 56' 35"E	3+34.44'	3+36.79'				(1614947.2547',472624.9099',933.26')	(1614949.5804',472624.5807',933.32')	
10	Line	15.00'		S8° 03' 25"W	3+36.79'	3+51.79'				(1614949.5804',472624.5807',933.32')	(1614947.4781',472609.7288',933.02')	
11	Curve	48.06'	30.00'		3+51.79'	3+99.85'	91.7939 (d)	43.09'	S52° 09' 36"W	(1614947.4781',472609.7288',933.02')	(1614913.4525',472583.2976',929.80')	(1614943.2734',472580.0249')
12	Line	11.01'		S6° 15' 47"W	3+99.85'	4+10.85'				(1614913.4525',472583.2976',929.80')	(1614912.2519',472572.3579',929.07')	
13	Curve	46.18'	30.00'		4+10.85'	4+57.04'	88.2061 (d)	41.76'	S37° 50' 24"E	(1614912.2519',472572.3579',929.07')	(1614937.8682',472539.3813',928.06')	(1614942.0728',472569.0852')
14	Line	2.35'		S81° 56' 35"E	4+57.04'	4+59.39'				(1614937.8682',472539.3813',928.06')	(1614940.1940',472539.0521',928.15')	
15	Line	15.00'		S8° 03' 25"W	4+59.39'	4+74.39'				(1614940.1940',472539.0521',928.15')	(1614938.0916',472524.2001',927.85')	
16	Curve	94.25'	30.00'		4+74.39'	5+68.64'	180.0000 (d)	60.00'	S8° 03' 25"W	(1614938.0916',472524.2001',927.85')	(1614929.6823',472464.7923',923.94')	(1614933.8870',472494.4962')
17	Line	15.00'		S8° 03' 25"W	5+68.64'	5+83.64'				(1614929.6823',472464.7923',923.94')	(1614927.5800',472449.9404',924.14')	
18	Line	6.45'		N81° 56' 35"W	5+83.64'	5+90.08'				(1614927.5800',472449.9404',924.14')	(1614921.1972',472450.8439',923.23')	
19	Curve	39.02'	30.00'		5+90.08'	6+29.10'	74.5241 (d)	36.33'	S60° 47' 41"W	(1614921.1972',472450.8439',923.23')	(1614889.4875',472433.1182',918.96')	(1614916.9925',472421.1400')
20	Curve	9.46'	165.00'		6+29.10'	6+38.57'	3.2860 (d)	9.46'	S25° 10' 33"W	(1614889.4875',472433.1182',918.96')	(1614885.4625',472424.5553',918.07')	(1614738.2102',472498.9983')
21	Curve	58.95'	30.00'		6+38.57'	6+97.52'	112.5888 (d)	49.91'	S29° 28' 32"E	(1614885.4625',472424.5553',918.07')	(1614910.0229',472381.1019',915.28')	(1614912.2357',472411.0202')
22	Line	15.00'		S4° 13' 48"W	6+97.52'	7+12.52'				(1614910.0229',472381.1019',915.28')	(1614908.9165',472366.1428',915.48')	
23	Line	17.63'		N85° 46' 12"W	7+12.52'	7+30.15'				(1614908.9165',472366.1428',915.48')	(1614891.3359',472367.4430',914.43')	
24	Curve	81.26'	150.00'		7+30.15'	8+11.40'	31.0371 (d)	80.27'	S78° 42' 41"W	(1614891.3359',472367.4430',914.43')	(1614812.6236',472351.7310',909.48')	(1614880.2721',472217.8516')
25	Line	15.00'		N26° 48' 26"W	8+11.40'	8+26.40'				(1614812.6236',472351.7310',909.48')	(1614805.8587',472365.1189',909.35')	
26	Curve	149.04'	150.00'		8+26.40'	9+75.44'	56.9298 (d)	142.99'	N34° 43' 40"E	(1614805.8587',472365.1189',909.35')	(1614887.3150',472482.6345',923.24')	(1614738.2102',472498.9983')
27	Line	281.59'		N6° 15' 47"E	9+75.44'	12+57.03'				(1614887.3150',472482.6345',923.24')	(1614918.0344',472762.5465',941.63')	
28	Curve	79.17'	90.00'		12+57.03'	13+36.21'	50.4016 (d)	76.64'	N31° 27' 49"E	(1614918.0344',472762.5465',941.63')	(1614958.0386',472827.9203',944.15')	(1615007.4972',472752.7282')
29	Curve	32.11'	25.00'		13+36.21'	13+68.31'	73.5840 (d)	29.95'	N19° 52' 21"E	(1614958.0386',472827.9203',944.15')	(1614968.2180',472856.0827',945.05')	(1614944.3001',472848.8070')
30	Line	15.00'		N73° 04' 50"E	13+68.31'	13+83.31'				(1614968.2180',472856.0827',945.05')	(1614982.5687',472860.4481',945.35')	
31	Curve	32.11'	25.00'		13+83.31'	14+15.42'	73.5840 (d)	29.95'	S53° 42' 42"E	(1614982.5687',472860.4481',945.35')	(1615006.7063',472842.7247',945.98')	(1615006.4866',472867.7238')
32	Line	15.00'		S0° 30' 13"E	14+15.42'	14+30.42'				(1615006.7063',472842.7247',945.98')	(1615006.8381',472827.7253',946.03')	

CONSULTANT:

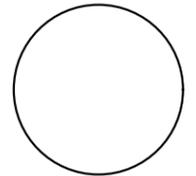

IOWA DEPARTMENT OF
NATURAL RESOURCES

ENGINEERING SERVICES - WALLACE BUILDING
502 E. 9TH ST., DES MOINES, IA 50319-0034



PAVING N LOOP ROAD I-SECTIONS WEST

CONSTRUCTION PROJECT FOR:

LAKE AHQUABI CAMPGROUND
UPGRADE PROJECT

WARREN COUNTY, IOWA

NO. BY DATE REVISION

DRAWN BY: PROJECT NUMBER:


22-05-91-01

CHKD BY: DATE:

12/29/2021

SHEET No:

108

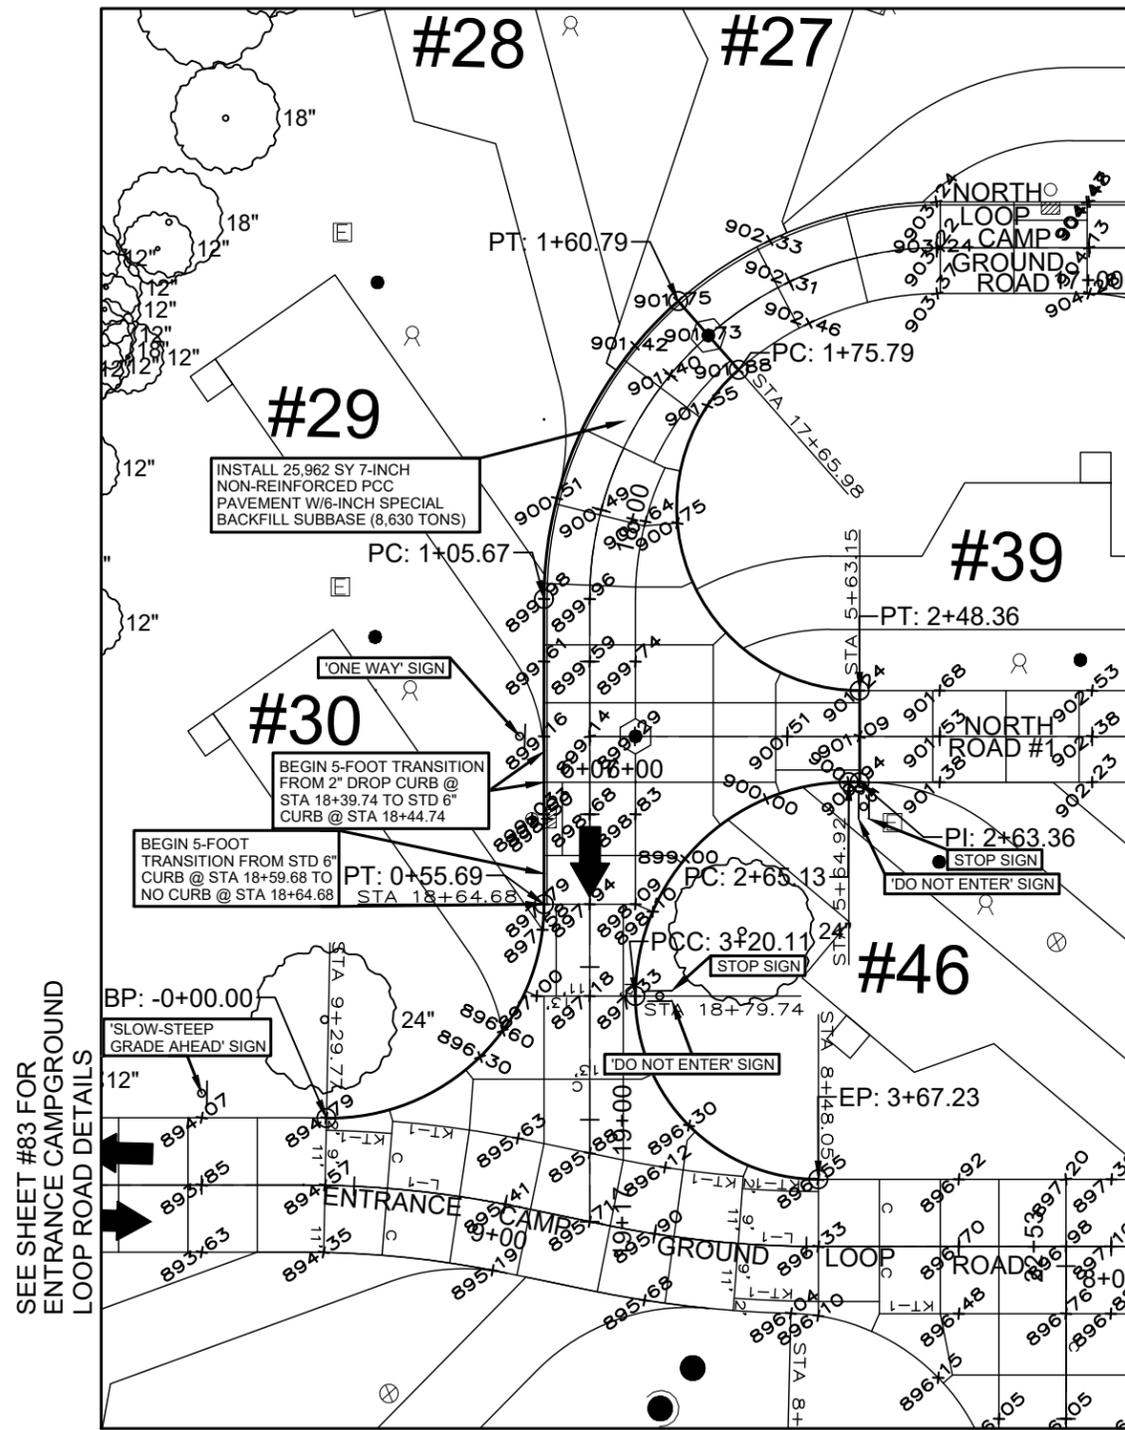


SEE SHEET #104 FOR NORTH LOOP CAMPGROUND ROAD DETAILS

SEE SHEET #111 FOR NORTH ROAD #1 DETAILS

SEE SHEET #83 FOR ENTRANCE CAMPGROUND LOOP ROAD DETAILS

SEE SHEET #83 FOR ENTRANCE CAMPGROUND LOOP ROAD DETAILS

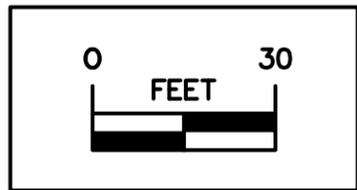

LEGEND
EXISTING/PROPOSED

○	●	MANHOLE
□	▣	INTAKE
⊕	⊕	HYDRANT
○	⊗	VALVE
□	□	OUTLET POST
○ PP/LP	● PP/LP	POWER POLE/ LIGHT POLE

OUTSIDE EDGE OF NORTH LOOP ROAD PAVEMENT INTERSECTION WITH NORTH ROAD #1 WEST SIDE												
No.	Type	Length	Radius	Direction	Start Station	End Station	Delta angle	Chord length	Chord Direction	Start Point	End Point	Center Point
1	Curve	55.69'	35.00'		0+00.00'	0+55.69'	91.1606 (d)	50.00'	N45° 34' 49"E	(1614553.3994', 472199.0260', 894.79')	(1614589.1084', 472234.0188', 897.79')	(1614554.1084', 472234.0188')
2	Line	49.98'		N0° 00' 00"E	0+55.69'	1+05.67'				(1614589.1084', 472234.0188', 897.79')	(1614589.1084', 472283.9983', 899.98')	
3	Curve	55.12'	65.00'		1+05.67'	1+60.79'	48.5904 (d)	53.49'	N24° 17' 43"E	(1614589.1084', 472283.9983', 899.98')	(1614611.1149', 472332.7483', 901.75')	(1614654.1084', 472283.9983')
4	Line	15.00'		S41° 24' 35"E	1+60.79'	1+75.79'				(1614611.1149', 472332.7483', 901.75')	(1614621.0365', 472321.4983', 901.88')	
5	Curve	72.57'	30.00'		1+75.79'	2+48.36'	138.5904 (d)	56.12'	S20° 42' 17"E	(1614621.0365', 472321.4983', 901.88')	(1614640.8796', 472268.9983', 901.24')	(1614640.8796', 472298.9983')
6	Line	15.00'		S0° 00' 00"E	2+48.36'	2+63.36'				(1614640.8796', 472268.9983', 901.24')	(1614640.8796', 472253.9983', 900.94')	
7	Line	1.77'		N90° 00' 00"W	2+63.36'	2+65.13'				(1614640.8796', 472253.9983', 900.94')	(1614639.1084', 472253.9983', 900.85')	
8	Curve	54.98'	35.00'		2+65.13'	3+20.11'	90.0000 (d)	49.50'	S45° 00' 00"W	(1614639.1084', 472253.9983', 900.85')	(1614604.1084', 472218.9983', 897.33')	(1614639.1084', 472218.9983')
9	Curve	47.12'	30.00'		3+20.11'	3+67.23'	90.0000 (d)	42.43'	S45° 00' 00"E	(1614604.1084', 472218.9983', 897.33')	(1614634.1084', 472188.9983', 896.55')	(1614634.1084', 472218.9983')

CONSULTANT:

IOWA DEPARTMENT OF NATURAL RESOURCES

ENGINEERING SERVICES - WALLACE BUILDING
502 E. 9TH ST., DES MOINES, IA 50319-0034

PAVING N LOOP ROAD I-SECTIONS WEST

CONSTRUCTION PROJECT FOR:
LAKE AHQUABI CAMPGROUND UPGRADE PROJECT
WARREN COUNTY, IOWA

DRAWN BY: PROJECT NUMBER: 22-05-91-01
CHKD BY: DATE: 12/29/2021





SHEET No: **109**

PROPOSED PROFILE GRADE NORTH ROAD #5								
No.	PVI Sta	PVI Elev	% In	% Out	% DIFF	Type	Length	K Value
1	0+00.00'	934.05'		4.41%				
2	0+11.56'	934.56'	4.41%	5.27%	0.86%			
3	0+53.14'	936.75'	5.27%	4.52%	0.74%			
4	1+25.00'	940.00'	4.52%	-2.87%	7.39%	Crest	120.00'	16.24
5	2+75.00'	935.70'	-2.87%	-3.81%	0.94%	Crest	50.00'	52.998
6	3+44.97'	933.03'	-3.81%	-1.58%	2.23%	Sag	50.00'	22.464
7	3+76.16'	932.54'	-1.58%	-1.73%	0.15%			
8	3+83.66'	932.41'	-1.73%					

LEGEND

EXISTING/PROPOSED


- MANHOLE
- MANHOLE
- INTAKE
- ⊗ HYDRANT
- VALVE
- ⊗ VALVE
- OUTLET POST
- PP/LP
- PP/LP
- POWER POLE/LIGHT POLE
- POWER POLE/LIGHT POLE

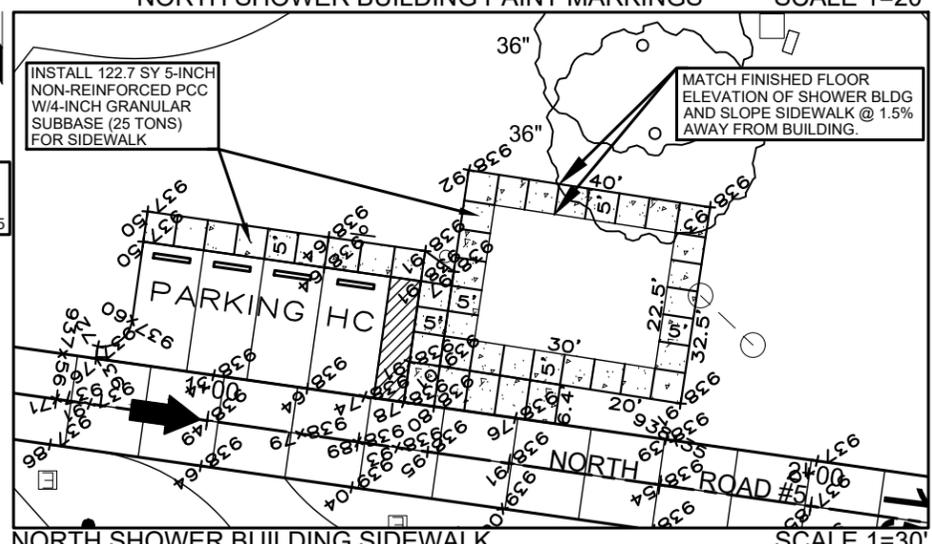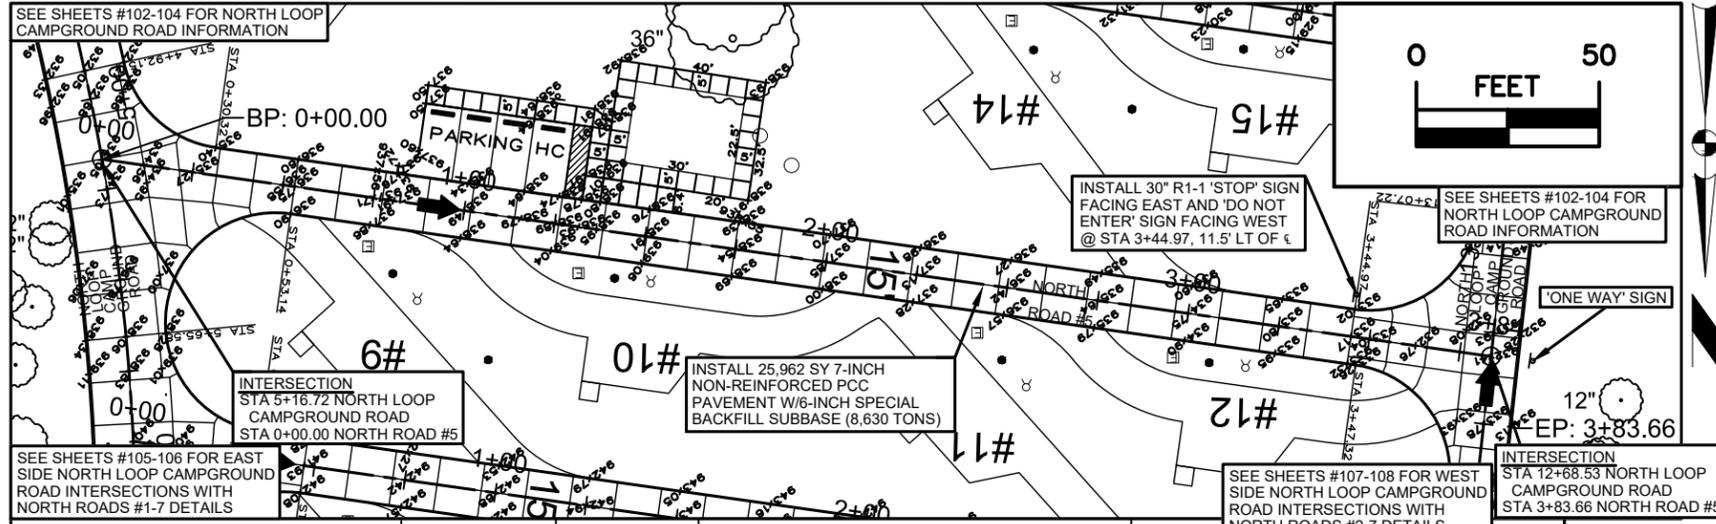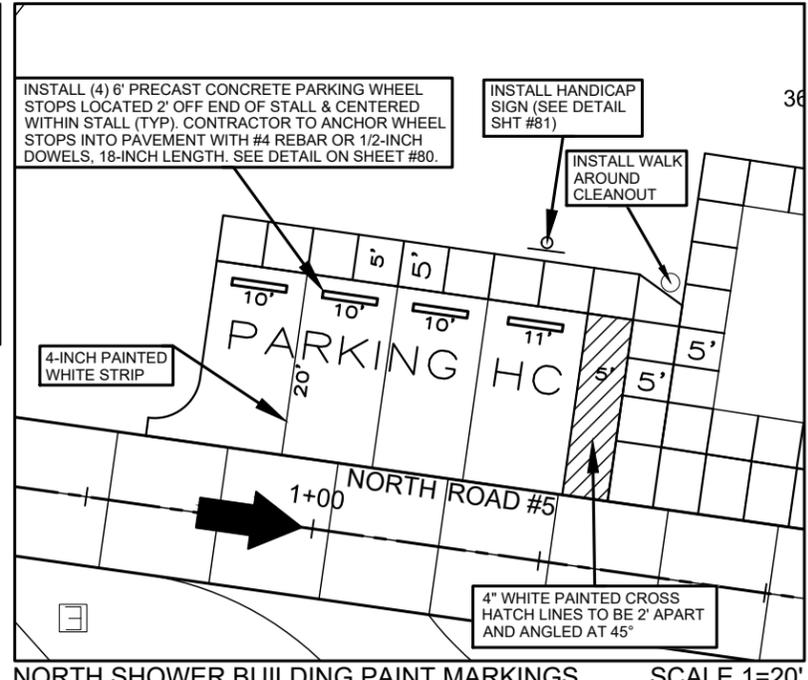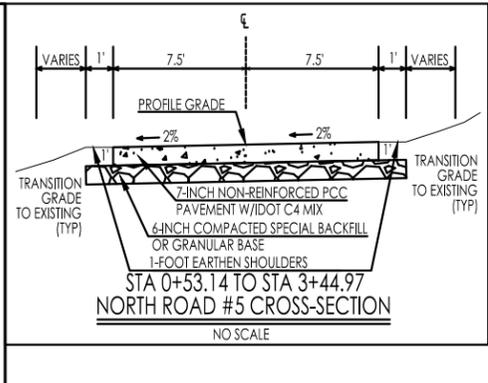

NORTH CAMPGROUND ROAD #5									
No.	Type	Length	Direction	Start Station	End Station	Start Point	End Point		
1	Line	383.66'	N81° 56' 35"W	0+00.00'	3+83.66'	(1615290.0941', 472568.8053', 934.05')	(1614910.2183', 472622.5777', 932.41')		

EXISTING PROFILE		PROPOSED PROFILE	
Station	Elevation	Station	Elevation
0+00.00	934.050	0+00.00	934.050
1+25.00	940.000	1+25.00	940.000
2+75.00	935.700	2+75.00	935.700
3+44.97	933.030	3+44.97	933.030
3+76.16	932.540	3+76.16	932.540
3+83.66	932.410	3+83.66	932.410

Station	Elevation
0+00	934.05
0+25	933.389
0+50	935.27
0+75	934.640
1+00	936.58
1+25	935.966
1+50	937.71
1+75	936.781
2+00	938.49
2+25	937.160
2+50	938.89
2+75	938.117
3+00	938.91
3+25	938.617
3+50	938.54
3+75	938.662
3+84	937.85
3+88	938.281
3+92	937.13
3+96	937.719
3+100	936.42
3+104	936.798
3+108	935.64
3+112	936.177
3+116	934.75
3+120	935.401
3+124	933.80
3+128	934.463
3+132	933.04
3+136	933.145
3+140	932.56
3+144	932.308
3+148	932.41
3+152	932.444

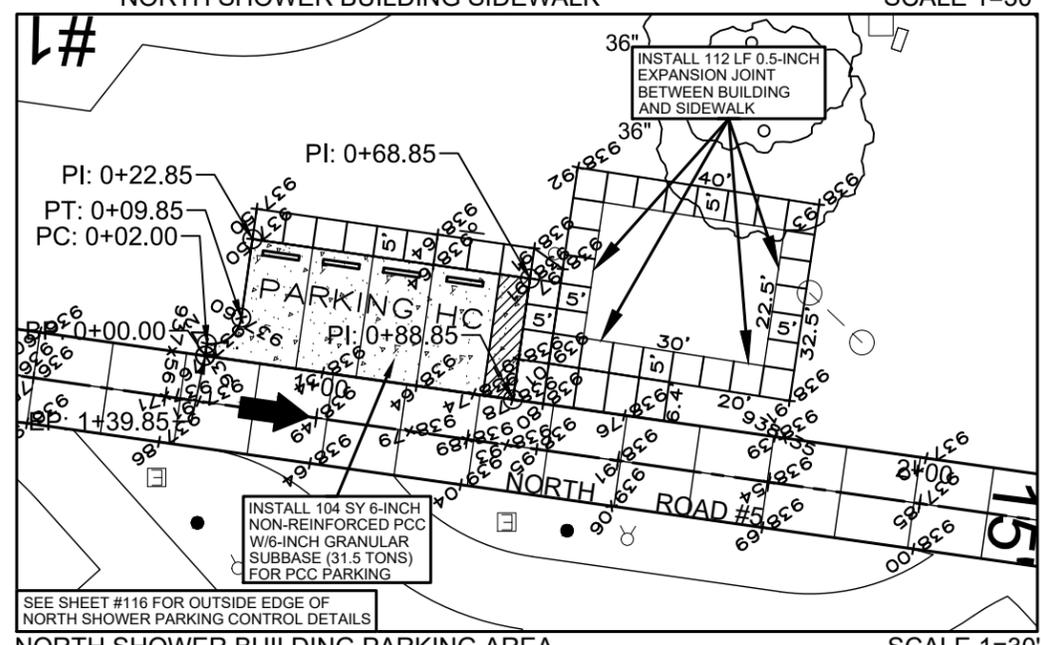

CONSULTANT:

IOWA DEPARTMENT OF NATURAL RESOURCES

ENGINEERING SERVICES - WALLACE BUILDING
502 E. 9TH ST., DES MOINES, IA 50319-0034

PAVING PLAN NORTH ROAD #5
CONSTRUCTION PROJECT FOR:
LAKE AHQUABI CAMPGROUND
UPGRADE PROJECT
WARREN COUNTY, IOWA


NO.	BY	REVISION

DRAWN BY: PROJECT NUMBER: 22-05-91-01
CHKD BY: DATE: 12/29/2021
SHEET NO: 115

OUTSIDE EDGE OF NORTH SHOWER PARKING AREA												
No.	Type	Length	Radius	Direction	Start Station	End Station	Delta angle	Chord length	Chord Direction	Start Point	End Point	Center Point
1	Line	2.00'		S8° 03' 25"W	0+00.00'	0+02.00'				(1615209.3135', 472572.6653', 937.76')	(1615209.0332', 472570.6850', 937.72')	
2	Curve	7.85'	5.00'		0+02.00'	0+09.85'	90.0000 (d)	7.07'	S53° 03' 25"W	(1615209.0332', 472570.6850', 937.72')	(1615203.3818', 472566.4351', 937.60')	(1615208.3324', 472565.7344')
3	Line	13.00'		S8° 03' 25"W	0+09.85'	0+22.85'				(1615203.3818', 472566.4351', 937.60')	(1615201.5597', 472553.5635', 937.50')	
4	Line	46.00'		N81° 56' 35"W	0+22.85'	0+68.85'				(1615201.5597', 472553.5635', 937.50')	(1615156.0138', 472560.0106', 938.91')	
5	Line	20.00'		N8° 03' 25"E	0+68.85'	0+88.85'				(1615156.0138', 472560.0106', 938.91')	(1615158.8169', 472579.8132', 938.78')	
6	Line	51.00'		S81° 56' 35"E	0+88.85'	1+39.85'				(1615158.8169', 472579.8132', 938.78')	(1615209.3135', 472572.6653', 937.76')	



SEE SHEET #115 FOR NORTH SHOWER PARKING AREA DETAILS

SEE SHEETS #102-104 FOR NORTH LOOP CAMPGROUND ROAD INFORMATION

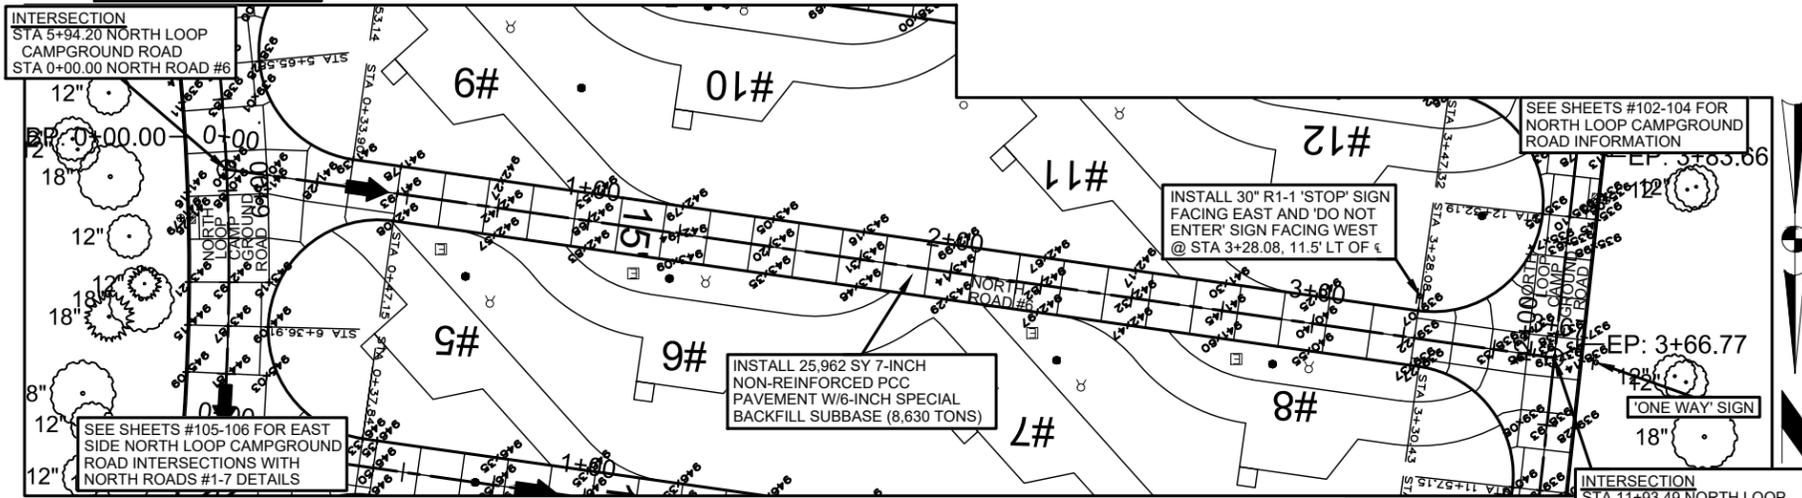

SEE SHEETS #102-104 FOR NORTH LOOP CAMPGROUND ROAD INFORMATION

SEE SHEETS #102-104 FOR NORTH LOOP CAMPGROUND ROAD INFORMATION

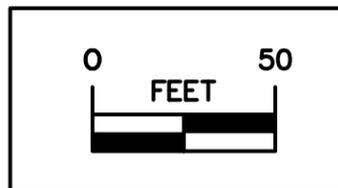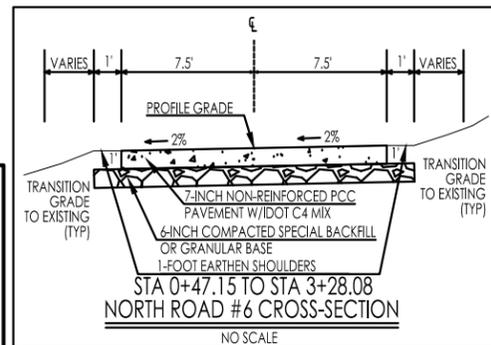


LEGEND

EXISTING/PROPOSED


○	●	MANHOLE
□	▣	INTAKE
⊕	⊖	HYDRANT
○	⊗	VALVE
□	⊞	OUTLET POST
○ PP/LP	● PP/LP	POWER POLE/ LIGHT POLE

NORTH CAMPGROUND ROAD #6							
No.	Type	Length	Direction	Start Station	End Station	Start Point	End Point
1	Line	366.77'	N81° 56' 35"W	0+00.00'	3+66.77'	(1615281.5567', 472645.7615', 0.0000')	(1614918.4042', 472697.1667', 0.0000')

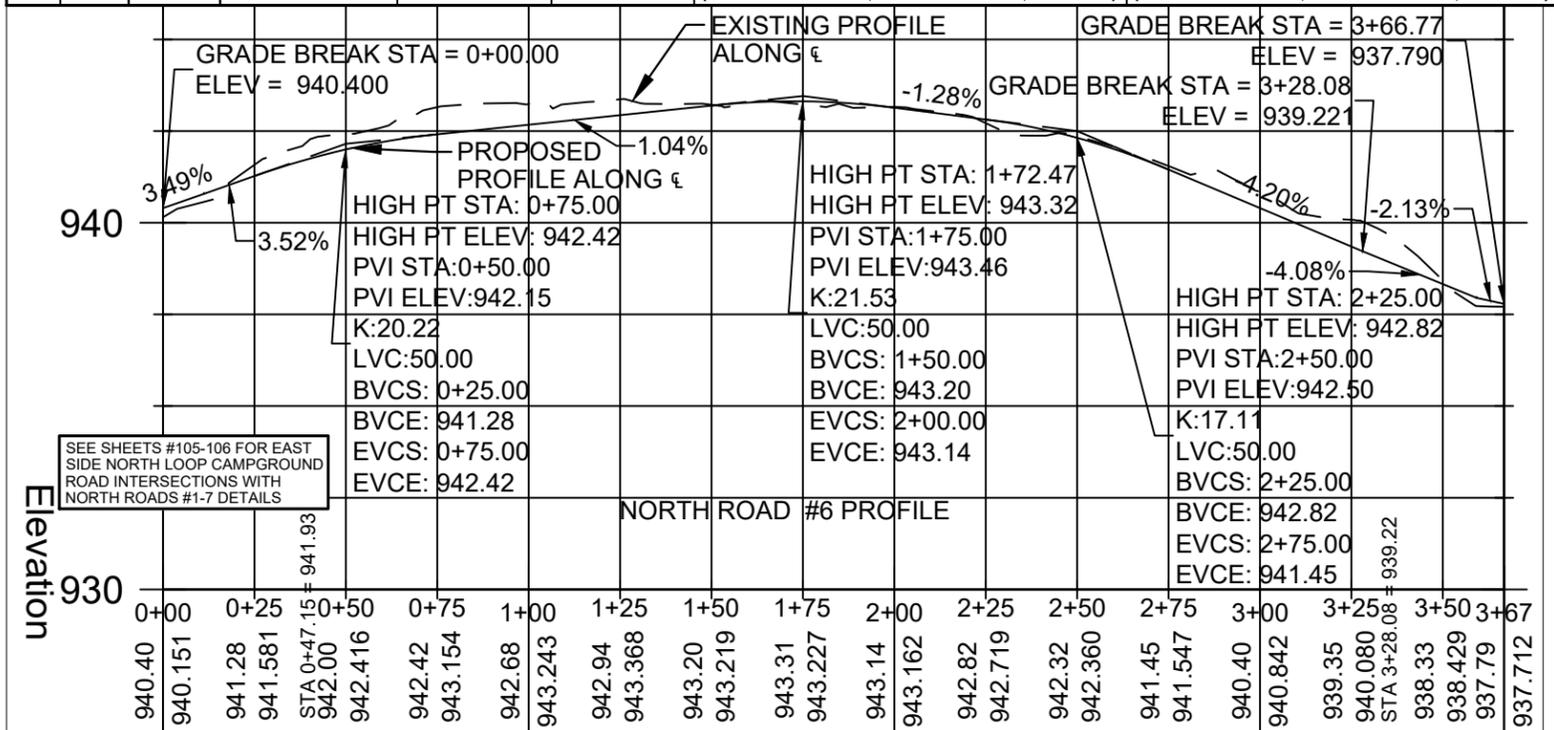

PROPOSED PROFILE GRADE NORTH ROAD #6							
No.	PVI Sta	PVI Elev	% In	% Out	% DIFF	Type	K Value
1	0+00.00'	940.40'		3.49%			
2	0+11.19'	940.79'	3.49%	3.52%	0.03%		
3	0+50.00'	942.15'	3.52%	1.04%	2.47%	Crest	50.00'
4	1+75.00'	943.46'	1.04%	-1.28%	2.32%	Crest	50.00'
5	2+50.00'	942.50'	-1.28%	-4.20%	2.92%	Crest	50.00'
6	3+28.08'	939.22'	-4.20%	-4.08%	0.12%		
7	3+59.26'	937.95'	-4.08%	-2.13%	1.95%		
8	3+66.77'	937.79'	-2.13%				

CONSULTANT:

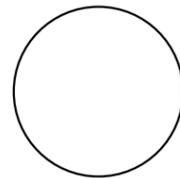

IOWA DEPARTMENT OF NATURAL RESOURCES

ENGINEERING SERVICES - WALLACE BUILDING
502 E. 9TH ST., DES MOINES, IA 50319-0034



PAVING PLAN NORTH ROAD #6

CONSTRUCTION PROJECT FOR:

LAKE AHQUABI CAMPGROUND UPGRADE PROJECT

WARREN COUNTY, IOWA




NO.	DATE	REVISION

DRAWN BY: PROJECT NUMBER: 22-05-91-01
CHKD BY: DATE: 12/29/2021

SHEET No:

116

PROPOSED PROFILE GRADE SHELTER ROAD							
No.	PVI Sta	PVI Elev	% In	% Out	% DIFF	Type	Length
1	0+00.00'	903.16'		-0.62%			
2	1+34.91'	902.33'	-0.62%	-2.52%	1.90%		
3	2+00.00'	900.69'	-2.52%	-3.64%	1.12%	Crest	50.00'
4	3+00.00'	897.05'	-3.64%	-4.00%	0.36%		
5	4+25.00'	892.05'	-4.00%	-3.24%	0.76%	Sag	50.00'
6	5+50.00'	888.00'	-3.24%	-1.17%	2.07%	Sag	50.00'
7	7+00.00'	886.25'	-1.17%	-1.34%	0.17%		
8	7+56.02'	885.50'	-1.34%				

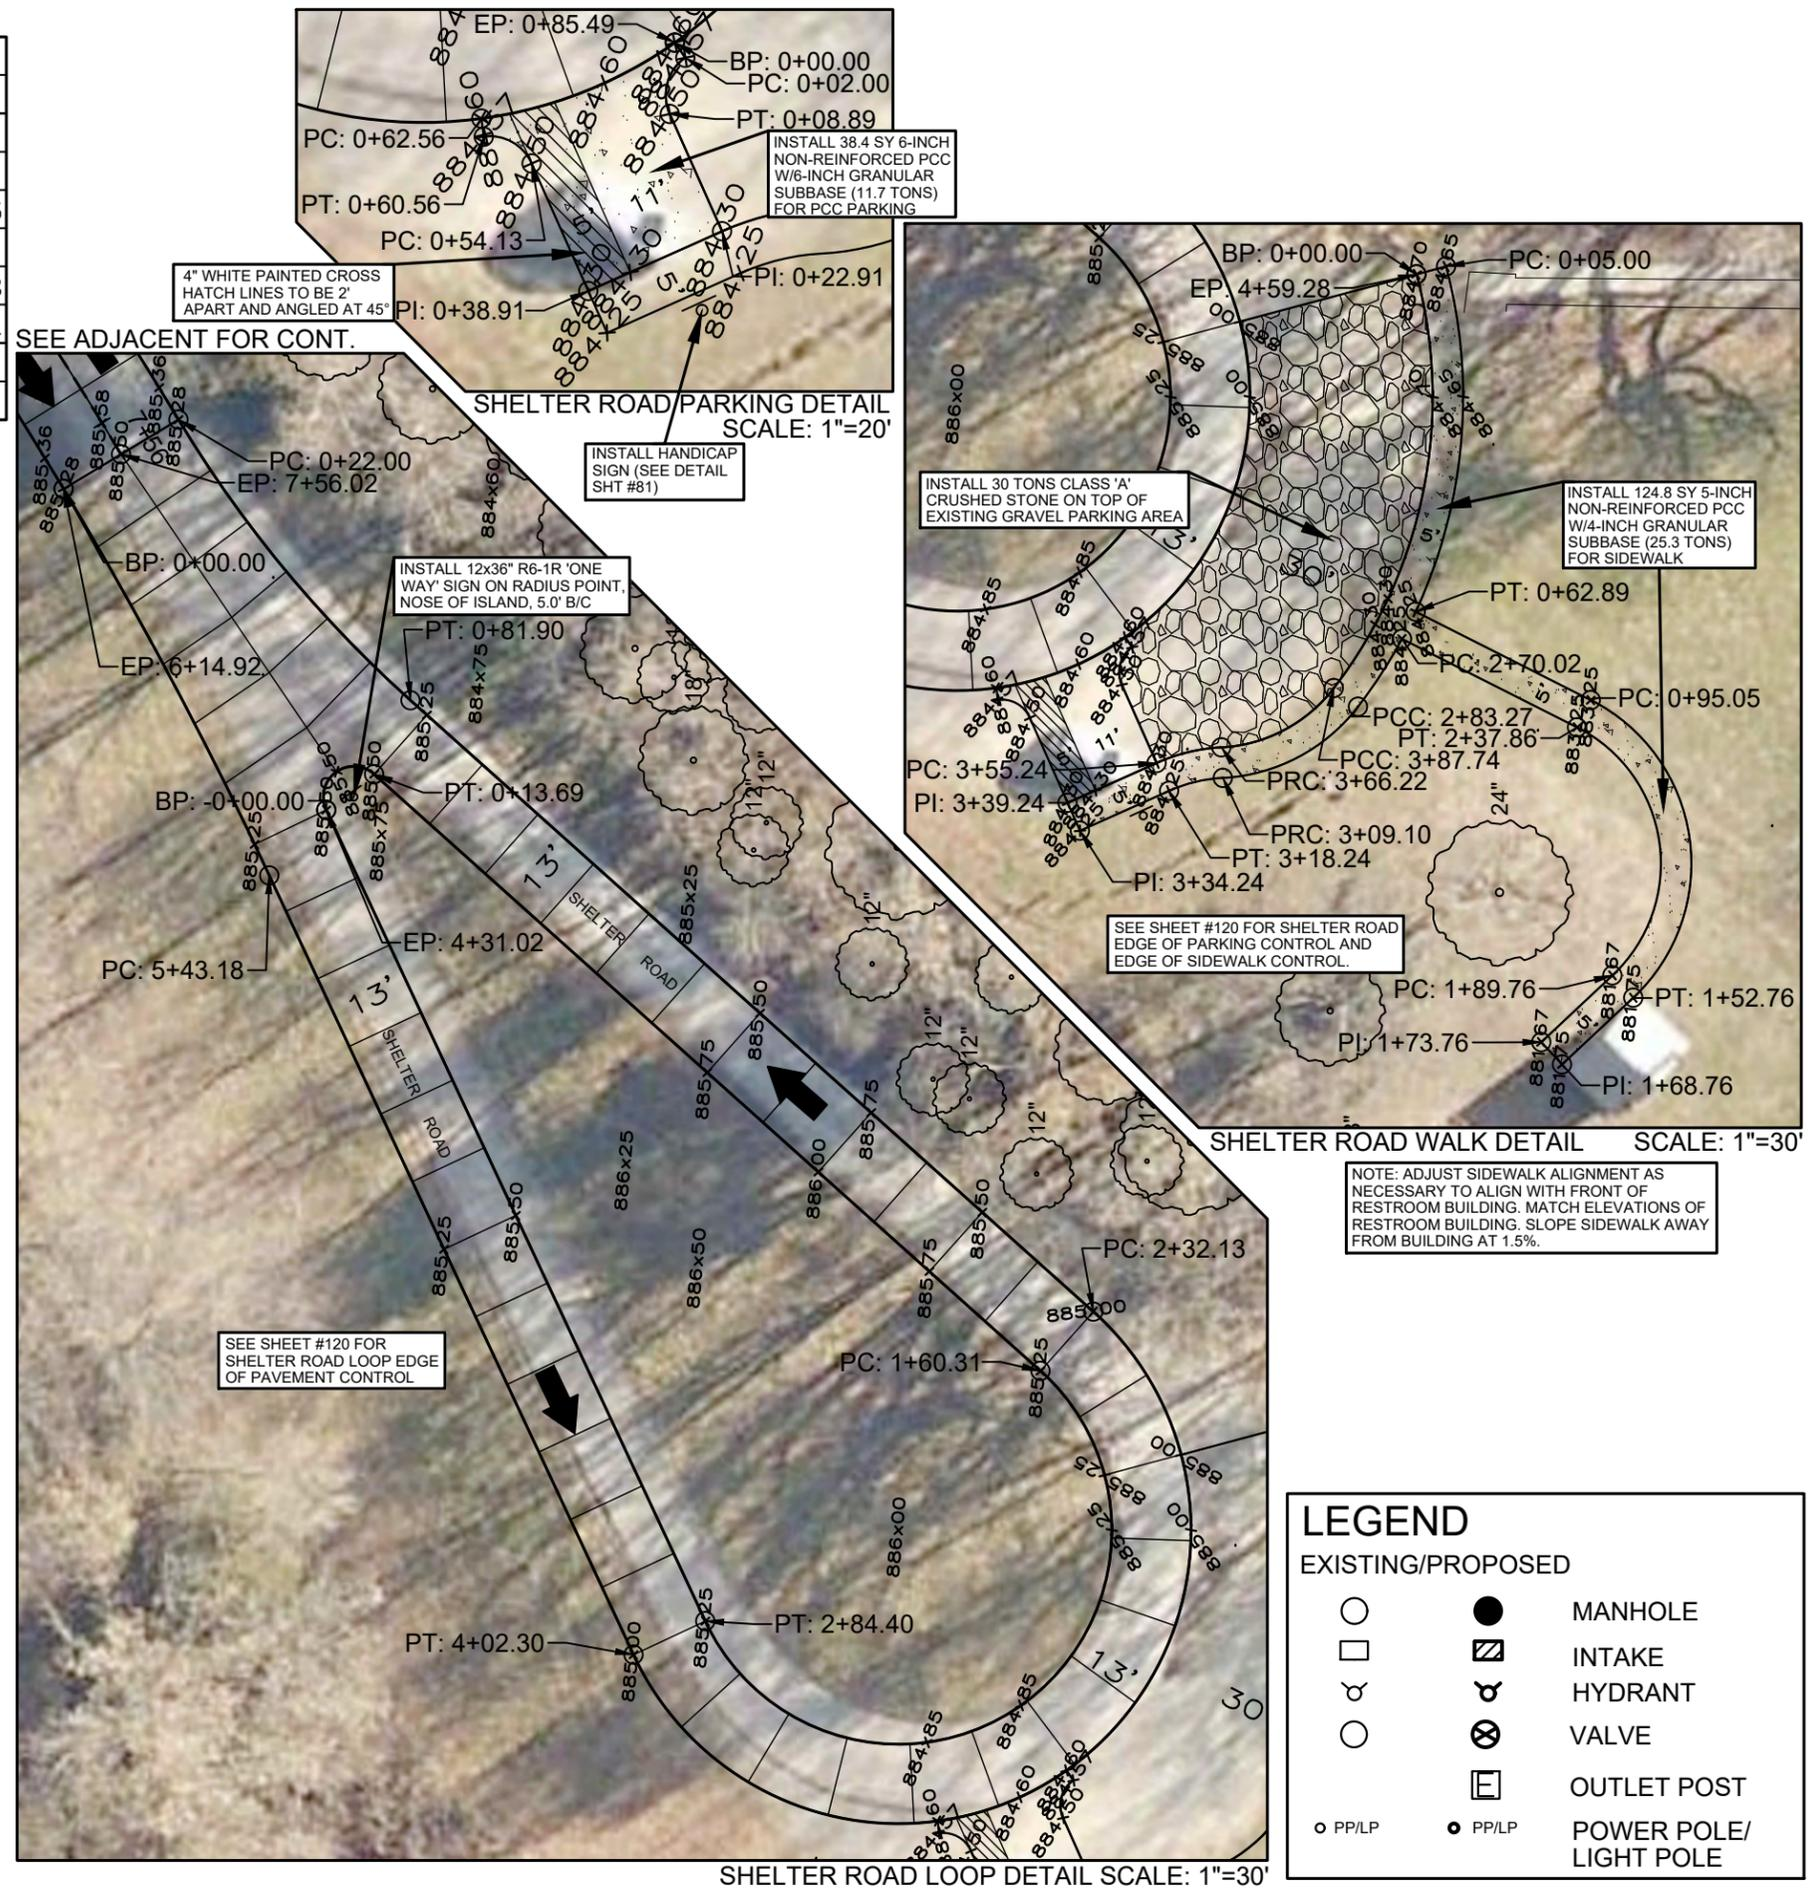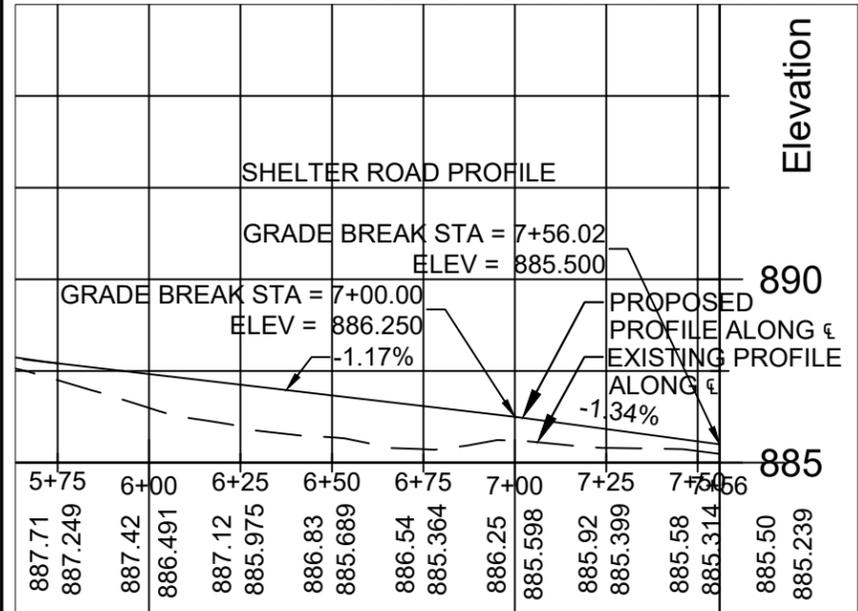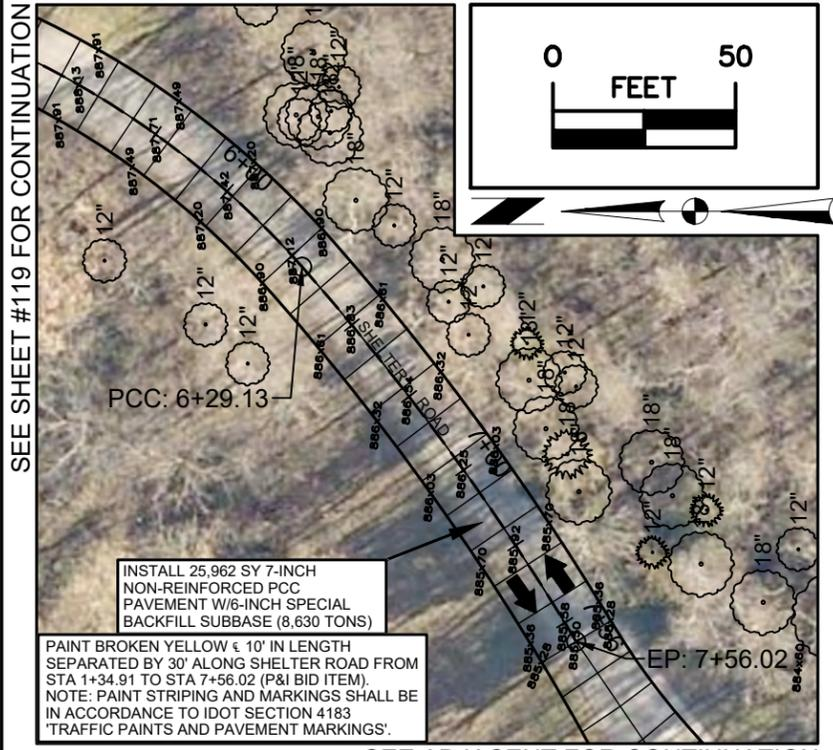

LEGEND		
EXISTING/PROPOSED		
○	●	MANHOLE
□	▨	INTAKE
⊕	⊖	HYDRANT
○	⊗	VALVE
○	□	OUTLET POST
○ PPI/LP	● PPI/LP	POWER POLE/ LIGHT POLE

CONSULTANT:

IOWA DEPARTMENT OF NATURAL RESOURCES
ENGINEERING SERVICES - WALLACE BUILDING
502 E. 9TH ST., DES MOINES, IA 50319-0034

PAVING PLAN SHELTER ROAD
CONSTRUCTION PROJECT FOR:
LAKE AHQUABI CAMPGROUND UPGRADE PROJECT
WARREN COUNTY, IOWA

NO.	BY	REVISION

DRAWN BY: PROJECT NUMBER:
22-05-91-01

CHKD BY: DATE:
12/29/2021


SHEET NO: **119**

OUTSIDE EDGE OF SHELTER ROAD LOOP												
No.	Type	Length	Radius	Direction	Start Station	End Station	Delta angle	Chord length	Chord Direction	Start Point	End Point	Center Point
1	Line	22.00'		S31° 04' 11"E	0+00.00'	0+22.00'				(1615195.3265',471538.3555',855.28')	(1615206.6804',471519.5116',855.28')	
2	Curve	59.90'	200.00'		0+22.00'	0+81.90'	17.1615 (d)	59.68'	S50° 20' 58"W	(1615206.6804',471519.5116',855.28')	(1615160.7288',471481.4288',885.25')	(1615309.8969',471348.2039')
3	Line	150.22'		S41° 46' 07"W	0+81.90'	2+32.13'				(1615160.7288',471481.4288',885.25')	(1615060.6610',471369.3859',885.00')	
4	Curve	170.17'	48.00'		2+32.13'	4+02.30'	203.1269 (d)	94.05'	N36° 40' 04"W	(1615060.6610',471369.3859',885.00')	(1615004.4958',471444.8256',885.00')	(1615024.8607',471401.3599')
5	Line	140.88'		N64° 53' 44"E	4+02.30'	5+43.18'				(1615004.4958',471444.8256',885.00')	(1615132.0673',471504.5964',885.25')	
6	Curve	71.74'	689.00'		5+43.18'	6+14.92'	5.9654 (d)	71.70'	N61° 54' 46"E	(1615132.0673',471504.5964',885.25')	(1615195.3265',471538.3555',855.28')	(1614839.7457',472128.5108')
INSIDE EDGE OF SHELTER ROAD LOOP												
No.	Type	Length	Radius	Direction	Start Station	End Station	Delta angle	Chord length	Chord Direction	Start Point	End Point	Center Point
1	Curve	13.69'	5.00'		0+00.00'	0+13.69'	156.8731 (d)	9.80'	S36° 40' 04"E	(1615142.7840',471495.2614',885.50')	(1615148.6345',471487.4031',885.25')	(1615144.9053',471490.7337')
2	Line	146.62'		S41° 46' 07"W	0+13.69'	1+60.31'				(1615148.6345',471487.4031',885.25')	(1615050.9651',471378.0455',885.25')	
3	Curve	124.08'	35.00'		1+60.31'	2+84.40'	203.1269 (d)	68.58'	N36° 40' 04"W	(1615050.9651',471378.0455',885.25')	(1615010.0113',471433.0536',885.50')	(1615024.8607',471401.3599')
4	Line	146.62'		N64° 53' 44"E	2+84.40'	4+31.02'				(1615010.0113',471433.0536',885.50')	(1615142.7840',471495.2614',885.50')	

OUTSIDE EDGE OF SHELTER ROAD PARKING AREA												
No.	Type	Length	Radius	Direction	Start Station	End Station	Delta angle	Chord length	Chord Direction	Start Point	End Point	Center Point
1	Line	2.00'		S54° 57' 47"W	0+00.00'	0+02.00'				(1614985.5592',471373.8028',884.60')	(1614983.9216',471372.6546',884.57')	
2	Curve	6.89'	5.00'		0+02.00'	0+08.89'	78.9942 (d)	6.36'	N74° 32' 02"W	(1614983.9216',471372.6546',884.57')	(1614977.7915',471374.3507',884.50')	(1614979.8277',471369.7841')
3	Line	14.01'		S65° 58' 08"W	0+08.89'	0+22.91'				(1614977.7915',471374.3507',884.50')	(1614964.9944',471368.6448',884.30')	
4	Line	16.00'		N24° 01' 52"W	0+22.91'	0+38.91'				(1614964.9944',471368.6448',884.30')	(1614958.4787',471383.2580',884.30')	
5	Line	15.23'		N65° 58' 08"E	0+38.91'	0+54.13'				(1614958.4787',471383.2580',884.30')	(1614972.3880',471389.4598',884.50')	
6	Curve	6.43'	5.00'		0+54.13'	0+60.56'	73.6313 (d)	5.99'	N29° 09' 12"E	(1614972.3880',471389.4598',884.50')	(1614975.3071',471394.6931',884.57')	(1614970.3518',471394.0264')
7	Line	2.00'		N82° 20' 16"E	0+60.56'	0+62.56'				(1614975.3071',471394.6931',884.57')	(1614977.2893',471394.9598',884.60')	
8	Curve	22.93'	48.00'		0+62.56'	0+85.49'	27.3746 (d)	22.72'	S21° 20' 59"E	(1614977.2893',471394.9598',884.60')	(1614985.5592',471373.8028',884.60')	(1615024.8607',471401.3599')

OUTSIDE EDGE OF SHELTER ROAD SIDEWALK AREA												
No.	Type	Length	Radius	Direction	Start Station	End Station	Delta angle	Chord length	Chord Direction	Start Point	End Point	Center Point
1	Line	5.00'		S14° 56' 45"E	0+00.00'	0+05.00'				(1615044.9774',471325.9986',884.70')	(1615046.2670',471321.1678',884.65')	
2	Curve	57.89'	83.00'		0+05.00'	0+62.89'	39.9589 (d)	56.72'	N84° 57' 59"W	(1615046.2670',471321.1678',884.65')	(1614989.7664',471326.1443',884.25')	(1615024.8607',471401.3599')
3	Line	32.17'		S26° 44' 20"W	0+62.89'	0+95.05'				(1614989.7664',471326.1443',884.25')	(1614975.2933',471297.4165',883.25')	
4	Curve	57.71'	30.00'		0+95.05'	1+52.76'	110.2206 (d)	49.22'	S81° 50' 58"W	(1614975.2933',471297.4165',883.25')	(1614926.5751',471290.4389',881.75')	(1614948.5013',471310.9143')
5	Line	16.00'		N43° 02' 25"W	1+52.76'	1+68.76'				(1614926.5751',471290.4389',881.75')	(1614915.6549',471302.1329',881.75')	
6	Line	5.00'		N46° 57' 35"E	1+68.76'	1+73.76'				(1614915.6549',471302.1329',881.75')	(1614919.3093',471305.5454',881.67')	
7	Line	16.00'		S43° 02' 25"E	1+73.76'	1+89.76'				(1614919.3093',471305.5454',881.67')	(1614930.2295',471293.8515',881.67')	
8	Curve	48.09'	25.00'		1+89.76'	2+37.86'	110.2206 (d)	41.01'	N81° 50' 58"E	(1614930.2295',471293.8515',881.67')	(1614970.8279',471299.6661',883.25')	(1614948.5013',471310.9143')
9	Line	32.17'		N26° 44' 20"E	2+37.86'	2+70.02'				(1614970.8279',471299.6661',883.25')	(1614985.3010',471328.3939',884.25')	
10	Curve	13.25'	83.00'		2+70.02'	2+83.27'	9.1449 (d)	13.23'	N56° 57' 45"W	(1614985.3010',471328.3939',884.25')	(1614974.2072',471335.6086',884.25')	(1615024.8607',471401.3599')
11	Curve	25.82'	30.00'		2+83.27'	3+09.10'	49.3192 (d)	25.03'	N27° 43' 49"W	(1614974.2072',471335.6086',884.25')	(1614962.5588',471357.7670',884.25')	(1614992.5157',471359.3741')
12	Curve	9.15'	25.00'		3+09.10'	3+18.24'	20.9603 (d)	9.09'	N13° 33' 03"W	(1614962.5588',471357.7670',884.25')	(1614960.4278',471366.6086',884.25')	(1614937.5947',471356.4278')
13	Line	16.00'		N24° 01' 52"W	3+18.24'	3+34.24'				(1614960.4278',471366.6086',884.25')	(1614953.9121',471381.2218',884.25')	
14	Line	5.00'		N65° 58' 08"E	3+34.24'	3+39.24'				(1614953.9121',471381.2218',884.25')	(1614958.4787',471383.2580',884.30')	
15	Line	16.00'		S24° 01' 52"E	3+39.24'	3+55.24'				(1614958.4787',471383.2580',884.30')	(1614964.9944',471368.6448',884.30')	
16	Curve	10.97'	30.00'		3+55.24'	3+66.22'	20.9603 (d)	10.91'	S13° 33' 03"E	(1614964.9944',471368.6448',884.30')	(1614967.5516',471358.0349',884.30')	(1614937.5947',471356.4278')
17	Curve	21.52'	25.00'		3+66.22'	3+87.74'	49.3192 (d)	20.86'	S27° 43' 49"E	(1614967.5516',471358.0349',884.30')	(1614977.2586',471339.5696',884.30')	(1614992.5157',471359.3741')
18	Curve	71.55'	78.00'		3+87.74'	4+59.28'	52.5559 (d)	69.07'	S78° 40' 05"E	(1614977.2586',471339.5696',884.30')	(1615044.9774',471325.9986',884.70')	(1615024.8607',471401.3599')

CONSULTANT:

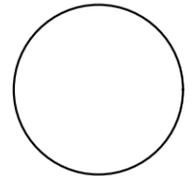

IOWA DEPARTMENT OF
NATURAL RESOURCES
ENGINEERING SERVICES - WALLACE BUILDING
502 E. 9TH ST., DES MOINES, IA 50319-0034



PAVING PLAN SHELTER ROAD

CONSTRUCTION PROJECT FOR:

LAKE AHQUABI CAMPGROUND
UPGRADE PROJECT

WARREN COUNTY, IOWA

NO. BY DATE REVISION

DRAWN BY: PROJECT NUMBER: 22-05-91-01

CHKD BY: DATE: 12/29/2021

SHEET No:

120

